

·				
INDE	EX OF SHEETS			
SHEET	DWG. NO	TITLE		
1	T-1	TITLE SHEET		
2	TS-01	TYPICAL SECTIONS & DETAILS		
3	GS-01	GEOMETRY SHEET		
4	EX-01	EXISTING CONDITIONS		
5	PS-01	ROADWAY PLAN		
6	PR-01	ROADWAY PROFILE		
7 TO 8	SW-01 TO SW-02	STORMWATER AND DRAINAGE PLAN / DETAILS		
9 TO 13	ESC-01 TO ESC-05	GRADING, EROSION AND SEDIMENT CONTROL		
14 TO 17	CS-01 TO CS-04	ROADWAY CROSS SECTIONS		
18	MT-01	DETOUR PLAN		
19	SN-01	SIGNING AND PAVEMENT MARKING PLAN	ΛΙΙΨ	יתמיות
20	S-1	BRIDGE GENERAL NOTES	ULLI	BERR
21	S-2	GENERAL PLAN, ELEVATION AND SECTION (EXISTING BRIDGE)		
22	S-3	GENERAL PLAN & ELEVATION		
23	S-4	HYDROLOGIC & HYDRAULIC DATA		
24	S-5	GEOMETRIC AND FOOTING LAYOUT		
25	S-6	ABUTMENT PILE LAYOUT PLAN		
26	S-7	ABUTMENT FOOTING REINFORCEMENT		
27	S-8	ABUTMENT A - PLAN, ELEVATION AND SECTION		
28	S-9	ABUTMENT B - PLAN, ELEVATION AND SECTION		
29	S-10	WING WALL ELEVATION AND SECTION		
30	S-11	SUPERSTRUCTURE TYPICAL SECTION		
31	S-12	BEAM LAYOUT		LA
32	S-13	NEXT BEAM DETAILS (1 OF 2)		
33	S-14	NEXT BEAM DETAILS (2 OF 2)		
34	S-15	ABUTMENT DIAPHRAGM DETAILS		
35	S-16	EXPANSION BEARING DETAILS		· · ·
36	S-17	FIXED BEARING DETAILS		
37	S-18	APPROACH SLAB AND EXPANSION JOINT DETAILS		
38	S-19	BRIDGE PARAPET REINFORCEMENT		
39	S-20	FINISHED DECK ELEVATIONS		
40 TO 41	S-20 S-21 TO S-22	BORING LOGS (2 SHEETS)		
40 TO 41 42 TO 43		REFERENCED DETAILS (2 SHEETS)		
				AND -
	ARE REQUIRED FOR TH	DARDS (CONSTRUCTION AND TEMPORARY TRAFFIC CONTROL) HIS PROJECT:		Ro
		ABLE VARIABLE MESSAGE SIGN PLACEMENT - ALL ROADWAYS /ALL SPE	EDS	
		TRAFFIC BARRIER END TREATMENT BARRIER W BEAM SINGLE FACE		OB RU
	d. 605.41 - TRAFFIC	BARRIER THRIE BEAM ANCHORAGE TO VERTICAL FACE (STEEL POST)		ISOR MANOR
	FOR ALL DETAILS REF	ERRED TO ON THE PLANS THE CONTRACTOR MUST GO TO		
		RDS WHICH WILL HAVE THE MOST CURRENT VERSION. THE		
	BOOK OF STANDARDS	CAN BE ACCESSED AT:		Í
		naryland.gov/businesswithsha/bizStdsSpecs/desManualStdPub		
	/publicationsonline/	/ohd/bookstd/index.asp		Ĩ
		E CONSTRUCTED IN ACCORDANCE WITH THE CURRENT VERSION OF		Ē)
	THE REFERENCED DET	AILS AT THE TIME OF CONSTRUCTION.		TRAL
<u>GEN</u>	IERAL NOTES			TOBACCO TRAIL
l I.	THE EXISTING UTILITIE	S AND OBSTRUCTIONS SHOWN ARE FROM THE BEST AVAILABLE		LOCATED IN F
		BE VERIFIED BY THE CONTRACTOR TO HIS SATISFACTION PRIOR		
		ECESSARY PRECAUTIONS SHALL BE TAKEN BY THE CONTRACTOR S SERVICES AND ANY DAMAGE TO THEM SHALL BE REPAIRED		
1	IMMEDIATELY AT HIS (	OWN EXPENSE.		
2.	IT SHALL BE DISTINCT	LY UNDERSTOOD THAT FAILURE TO MENTION SPECIFICALLY ANY		/IATIONS
	WORK WHICH WOULD N	ATURALLY BE REQUIRED TO COMPLETE THE PROJECT SHALL NOT	P.G.L.	PROFILE GRADE LINE
	RELIEVE THE CONTRAC	CTOR OF HIS RESPONSIBILITY TO COMPLETE SUCH WORK.	BL ELEV.	BASELINE ELEVATION
		ALL CALL "MISS UTILITY" (I-800-257-7777) A MINIMUM OF 48 HOURS	STA.	STATION
	IN ADVANCE OF ANY E THE LOCATION OF UNE	EXCAVATION, BORING, PILE DRIVING AND/OR DIGGING TO DETERMINE	L.F.	LINEAR FEET
	THE LOCATION OF UNL	JERGROUND UTIETTES.	S.Y.	SQUARE YARD
		ASEMENT LINES SHOWN ON THESE PLANS ARE FOR ASSISTANCE IN	C.Y. STD.	CUBIC YARD STANDARD
	INTERPRETING PLANS PLATS.	ONLY.FOR DETAILED INFORMATION SEE THE APPROPRIATE RIGHT-OF-WAY	R/W	RIGHT OF WAY
				EXISTING
		SHOWN ON THE PLANS ARE NOT TO BE EXCEEDED. ANY DING, EROSION AND SEDIMENT CONTROL PLAN OR OTHER SEGMENT	EX.	LEFT
		BE REVIEWED AND APPROVED BY THE ENGINEER.	LT. RT.	RIGHT
_ م		ATAPONICREEK IS A USE I WATERWAY. IN-STREAM WORK MAY NOT BE	111.0	
		RCH I THROUGH JUNE 15, INCLUSIVE, OF ANY YEAR.		

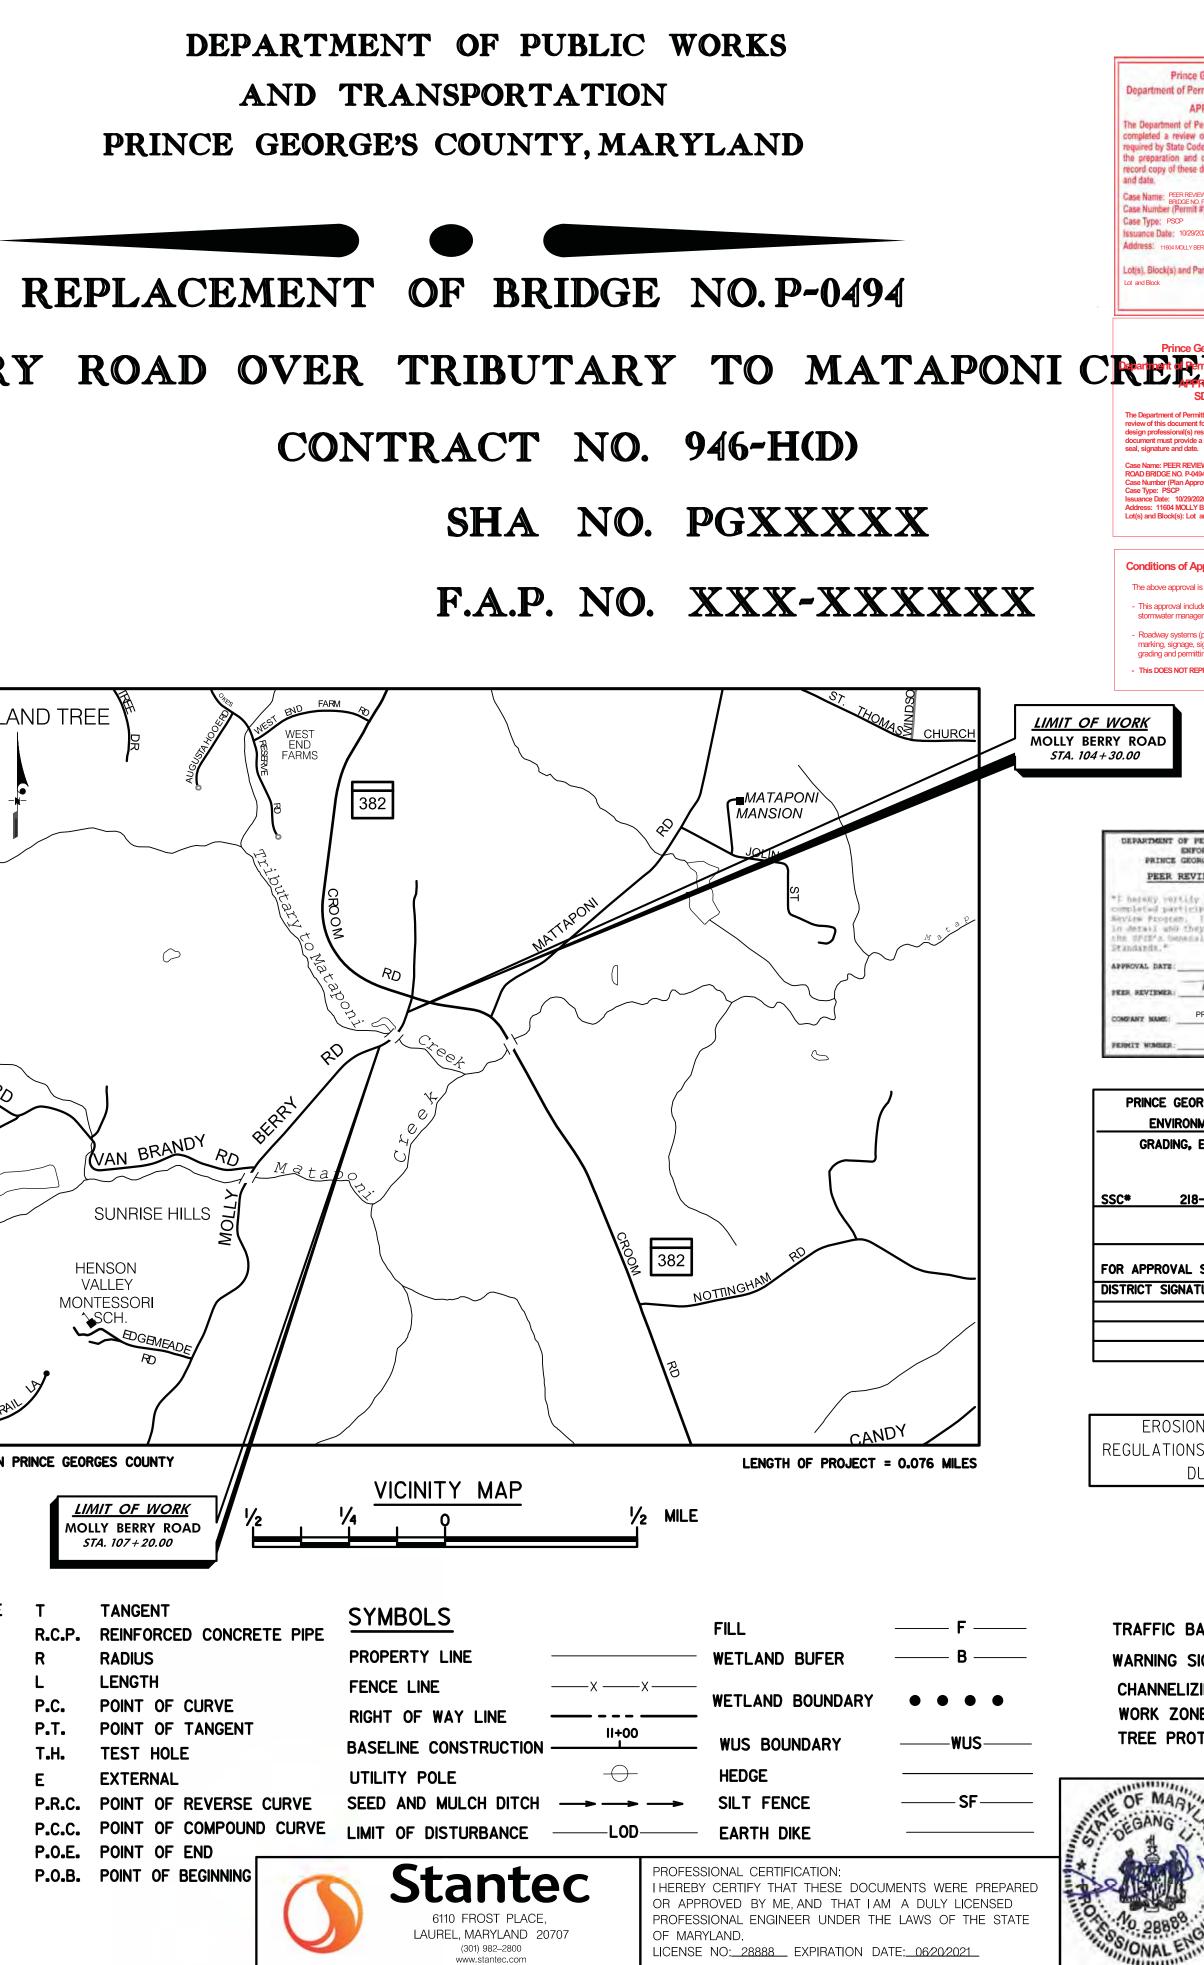


		F.H.W.A. Region No.	STATE	FED. AID PROJ. NO.	SHEET NO.	TOTAL SHEETS
		_	MD			43
						J
e George's County, Maryland ermitting, Inspections and Enforcement	OWNER'S/DEVEL	OPER'S/APPLIC	CANT IN	FORMATION		
PPROVED PERMIT SET Permitting, Inspections and Enforcement has v of this document for code compliance. As	NAME:			NTY GOVERNMENT IC WORKS AND TH		4
ode, the design professional(s) responsible for d content of this document must provide a e documents with their original seal, signature	ADDRESS:	INGLEWOOD	CENTER 3			
/IEW - DP/W&T-REPLACEMENT OF MOLLY BERRY ROAD IO. P-0494		9400 PEPPE Largo, MD (		ACE, SUITE 400		
17. 38382-2020-0	REPRESENTATIVE:		-	RIDGE DESIGN DIVI	SION	
BERRY RD UPPER MARLBORO, MD 20772	PHONE:	(301) 883-56				
MTayyem DPIE						
	CERTIFICATE OF				F	
George's County Maryland emitting, Inspections & Enforcement	PLAN BASED ON MY PE WERE PREPARED IN ACC	RSONAL KNOWLEDGE	OF THE	SITE AND THESE F	PLANS	
ROWED PLAN SET SD-SWM ONLY	GEORGE'S COUNTY DPW AND OTHER JURISDICTIO	&T DESIGN MANUAL	AND STAN	IDARD SPECIFICATI		
mitting, Inspections and Enforcement has completed a t for code compliance. As required by State Code, the responsible for the preparation and content of this e a record copy of these documents with their original			10/20/			
e. /IEW - DPW&T-REPLACEMENT OF MOLLY BERRY 1494	NAME:DEGANG_LI	MD LICEN	ISE NO	28888		
proval #): 38382-2020-0 2020 Y BERRY RD UPPER MARLBORC MD 772	NAME: STANTEC. ADDRESS: 6110 FROST F	PLACE, LAUREL, MAR	YLAND 20	707		
t and Block advertise to reserve						
Approval Mlayyem	OWNERS / DEVEL			—		
I is conditioned upon the following: udes plan approval by DPIE for storm drain and	I/WE HEREBY CERTIFY T DEVELOPMENT WILL BE I					
gement systems ONLY. s (paving, sidewalk, curb/gutter, pavement	PERSONNEL INVOLVED IN	THE CONSTRUCTION	PROJECT	WILL HAVE A CE	RTIFICATE OF	
signals and other roadway appurtenances), itting require further review. EPRESENT A PERMIT TO CONSTRUCT.	ATTENDANCE AT A MAR' TRAINING PROGRAM FOR	THE CONTROL OF S	EDIMENT A	ND EROSION BEFO	DRE	
	BEGINNING THE PROJECT. ON-SITE EVALUATION BY	STATE OF MARYLA				
	COMPLIANCE INSPECTORS					
	SIGNATURE:	$\sim$	DATE:	10/20/2020		
	Erv T. Beckert, P.E.		•			
	Chief, Highway and Bi Office of Engineerin	g and Project Ma	nagemen	(OE&PM)		
PERMITTING, INSPECTIONS AND PORCEMENT (DPIE) DRGE'S COUNTY, MARYLAND	Prince George's Coun Public Works and Tro	• •				
TEW APPROVAL STAMP						
y final i farme serverthilly Spaking (y 0218's Reyr I have reviewed these plans	UTILITY CERTIFIC					
al Theritications and	I HEREBY CERTIFY THAT		OR PROPO	SED UNDERGROUN	d utility	
10/28/2020	INFORMATION SHOWN HEP RECORDS. FURTHER. THAT					
PRINCE GEORGE'S DPW&T	INVOLVED UTILITY COMP. RELATIVE TO THE PLAN	ANY AND ALL AVAIL	ABLE UND	ERGROUND UTILITY		
38382-2020-0	SIGNATURE:		DATE:	10/20/2020		
	SIGNA   URE:		UATE:			
RGE'S SOIL CONSERVATION [		1	DESIGN	TRAFFIC D	ATA	$\neg$
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		AVERAGE DAIL	Y TRAFFIC		825	
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EXPIRA	TION DATE	FUNCTIONAL OF		ION RL	JRAL LOCAL	_
SIGNATURE, SEE SHEET *9	(ESC-0I)	CONTROL OF POSTED SPEE			NONE 30 mph	
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URING CONSTRUCTION					2020	
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PRINCE GEORGE'S COUNTY, MARYLAND   ING DRUMS   REPLACEMENT OF BRIDGE NO. P-0494   MOLLY BERRY ROAD OVER						494
	TP	TR	MOLLY	BERRY ROA	D OVER PONI CREEK	k l
TECTION	IF		Т	TILE SHEE	ΞT	
P	EVISIONS	SCALE: AS SHOW	/N		DWG. I	OF 43
(P)		-			Cote a Wagger	
Long .		APPROVED	D/20/2020 DATE	For Te	rry Bellamy, Dir	rector
5		DESIGNED: DL			CONTRAC	T NO.
Han I		DRAWN: VC CHECKED: PL			PROJEC	T NO.
inne		APPROVED: Erv T. Beckert, P.E. Chief, Highway and	Bridge Dec	<u>10/20/2020</u> DATE	FILE N	0.
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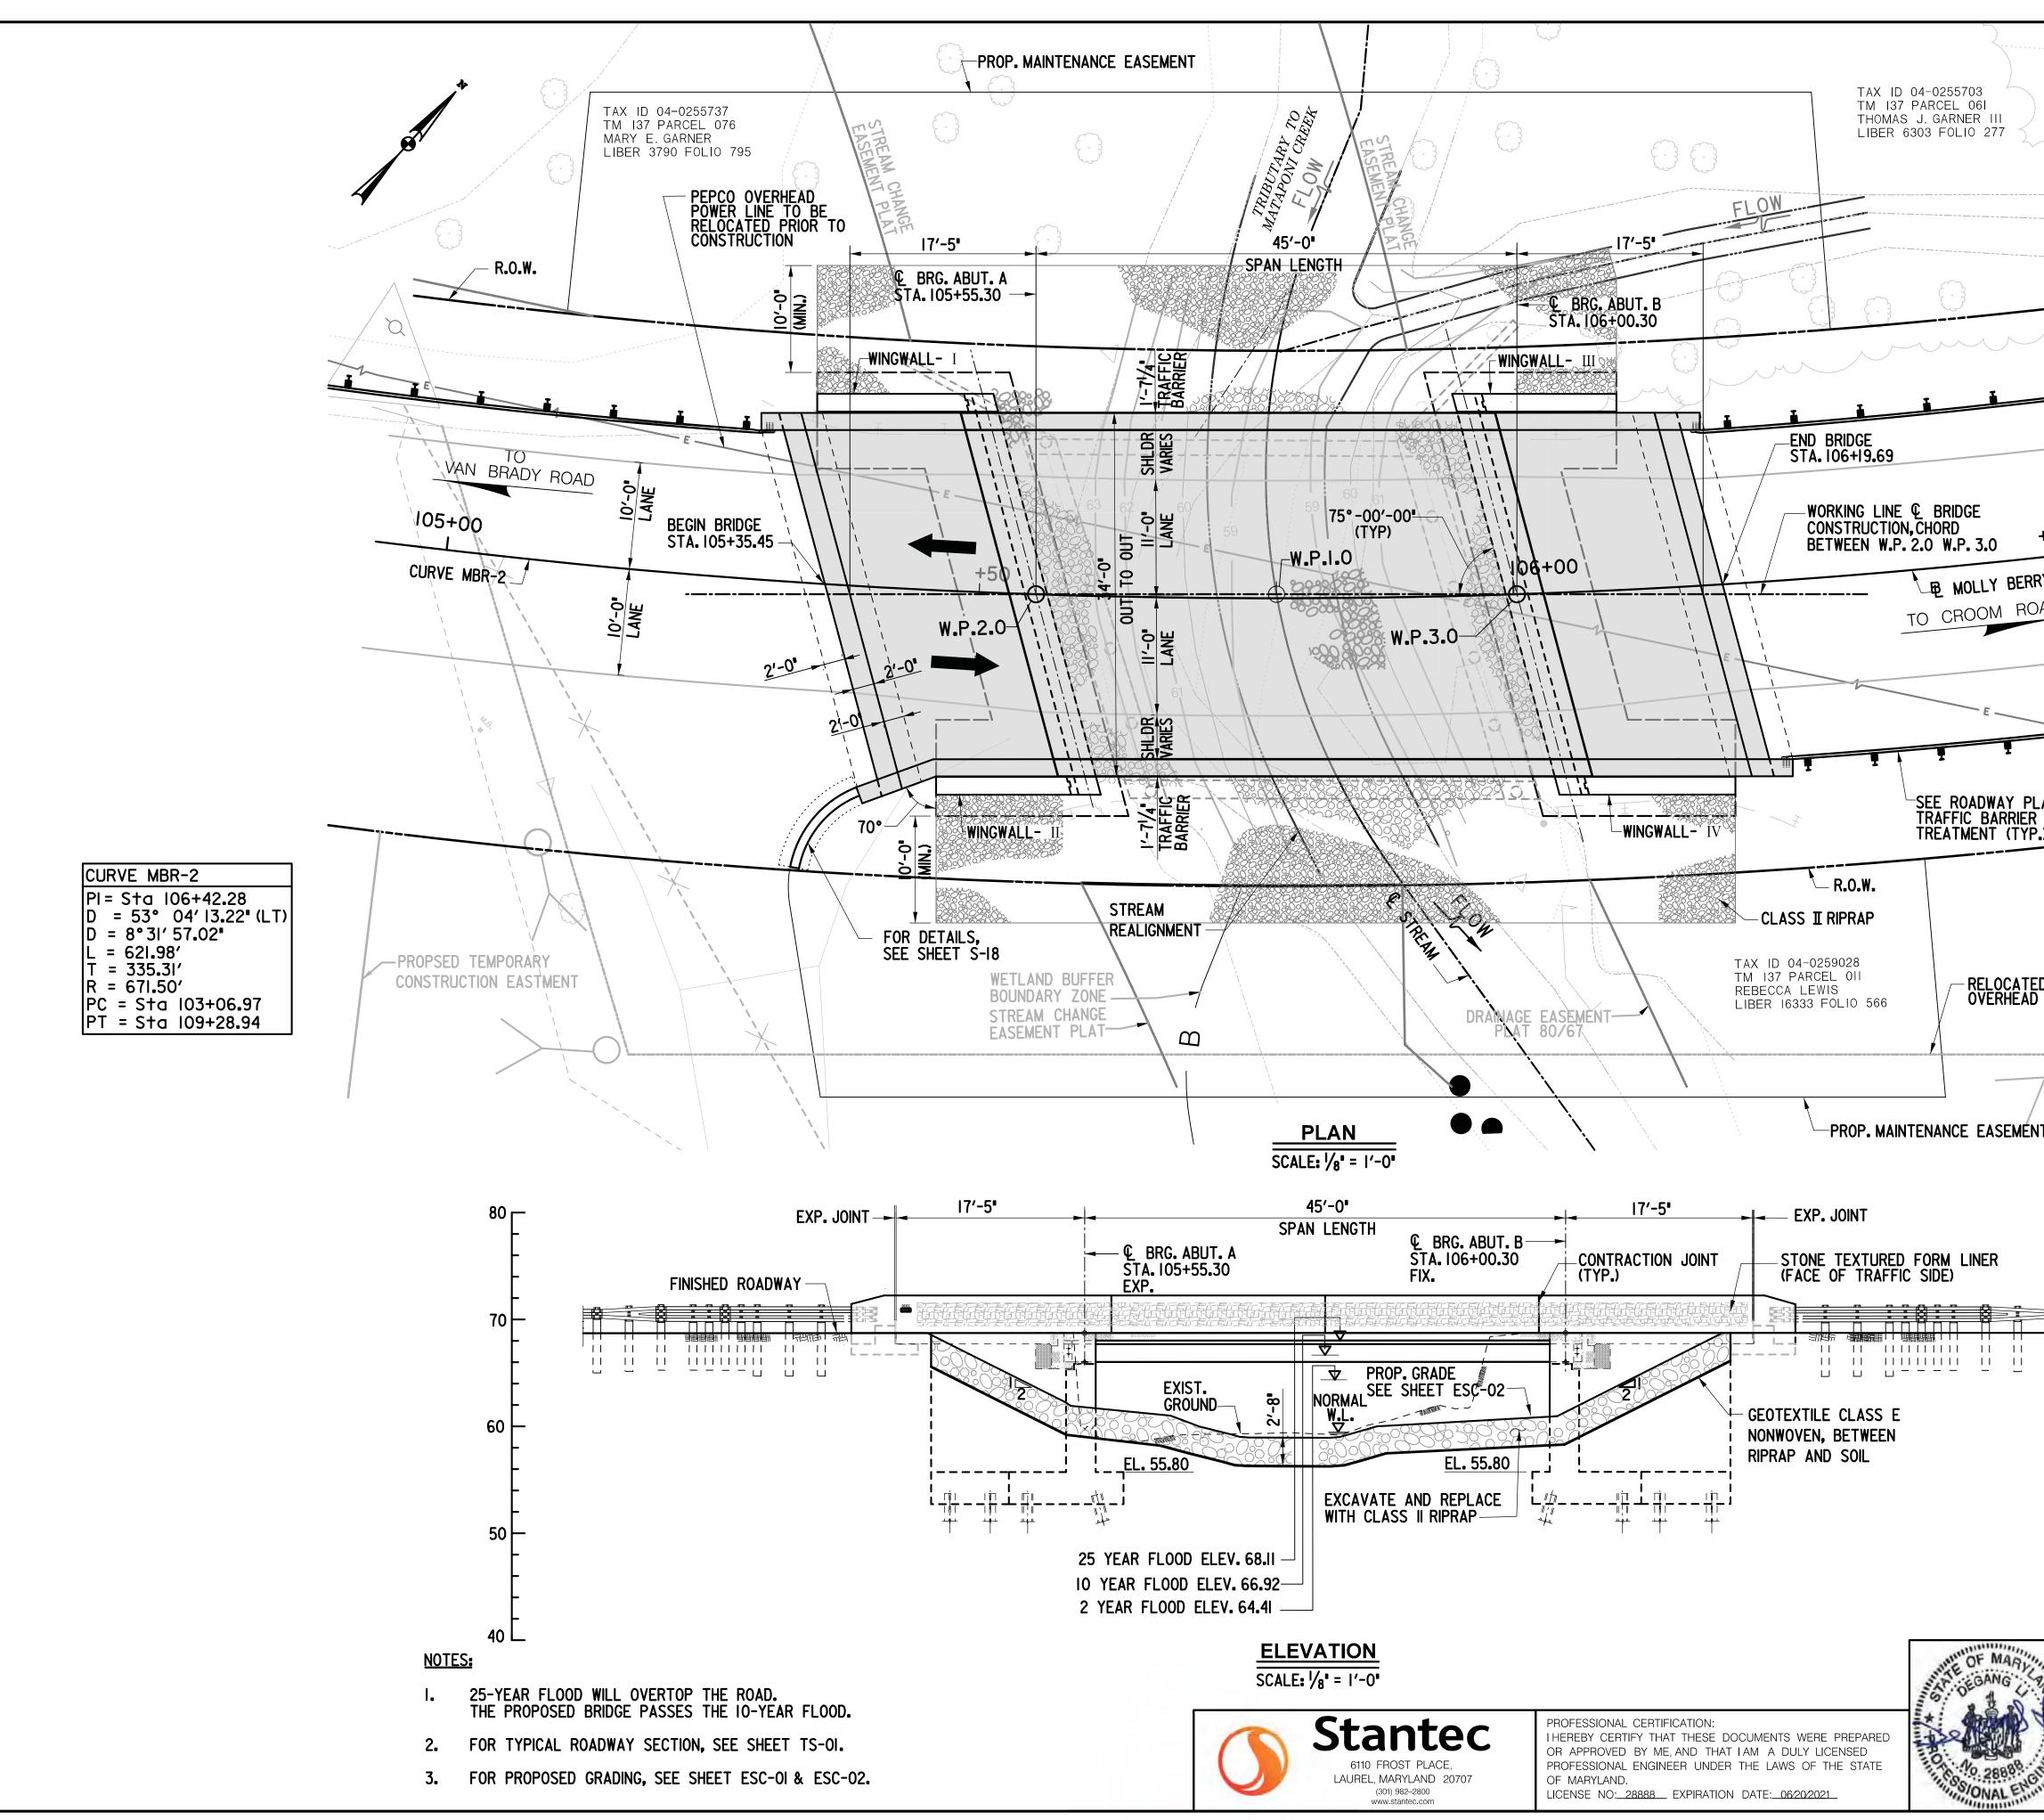


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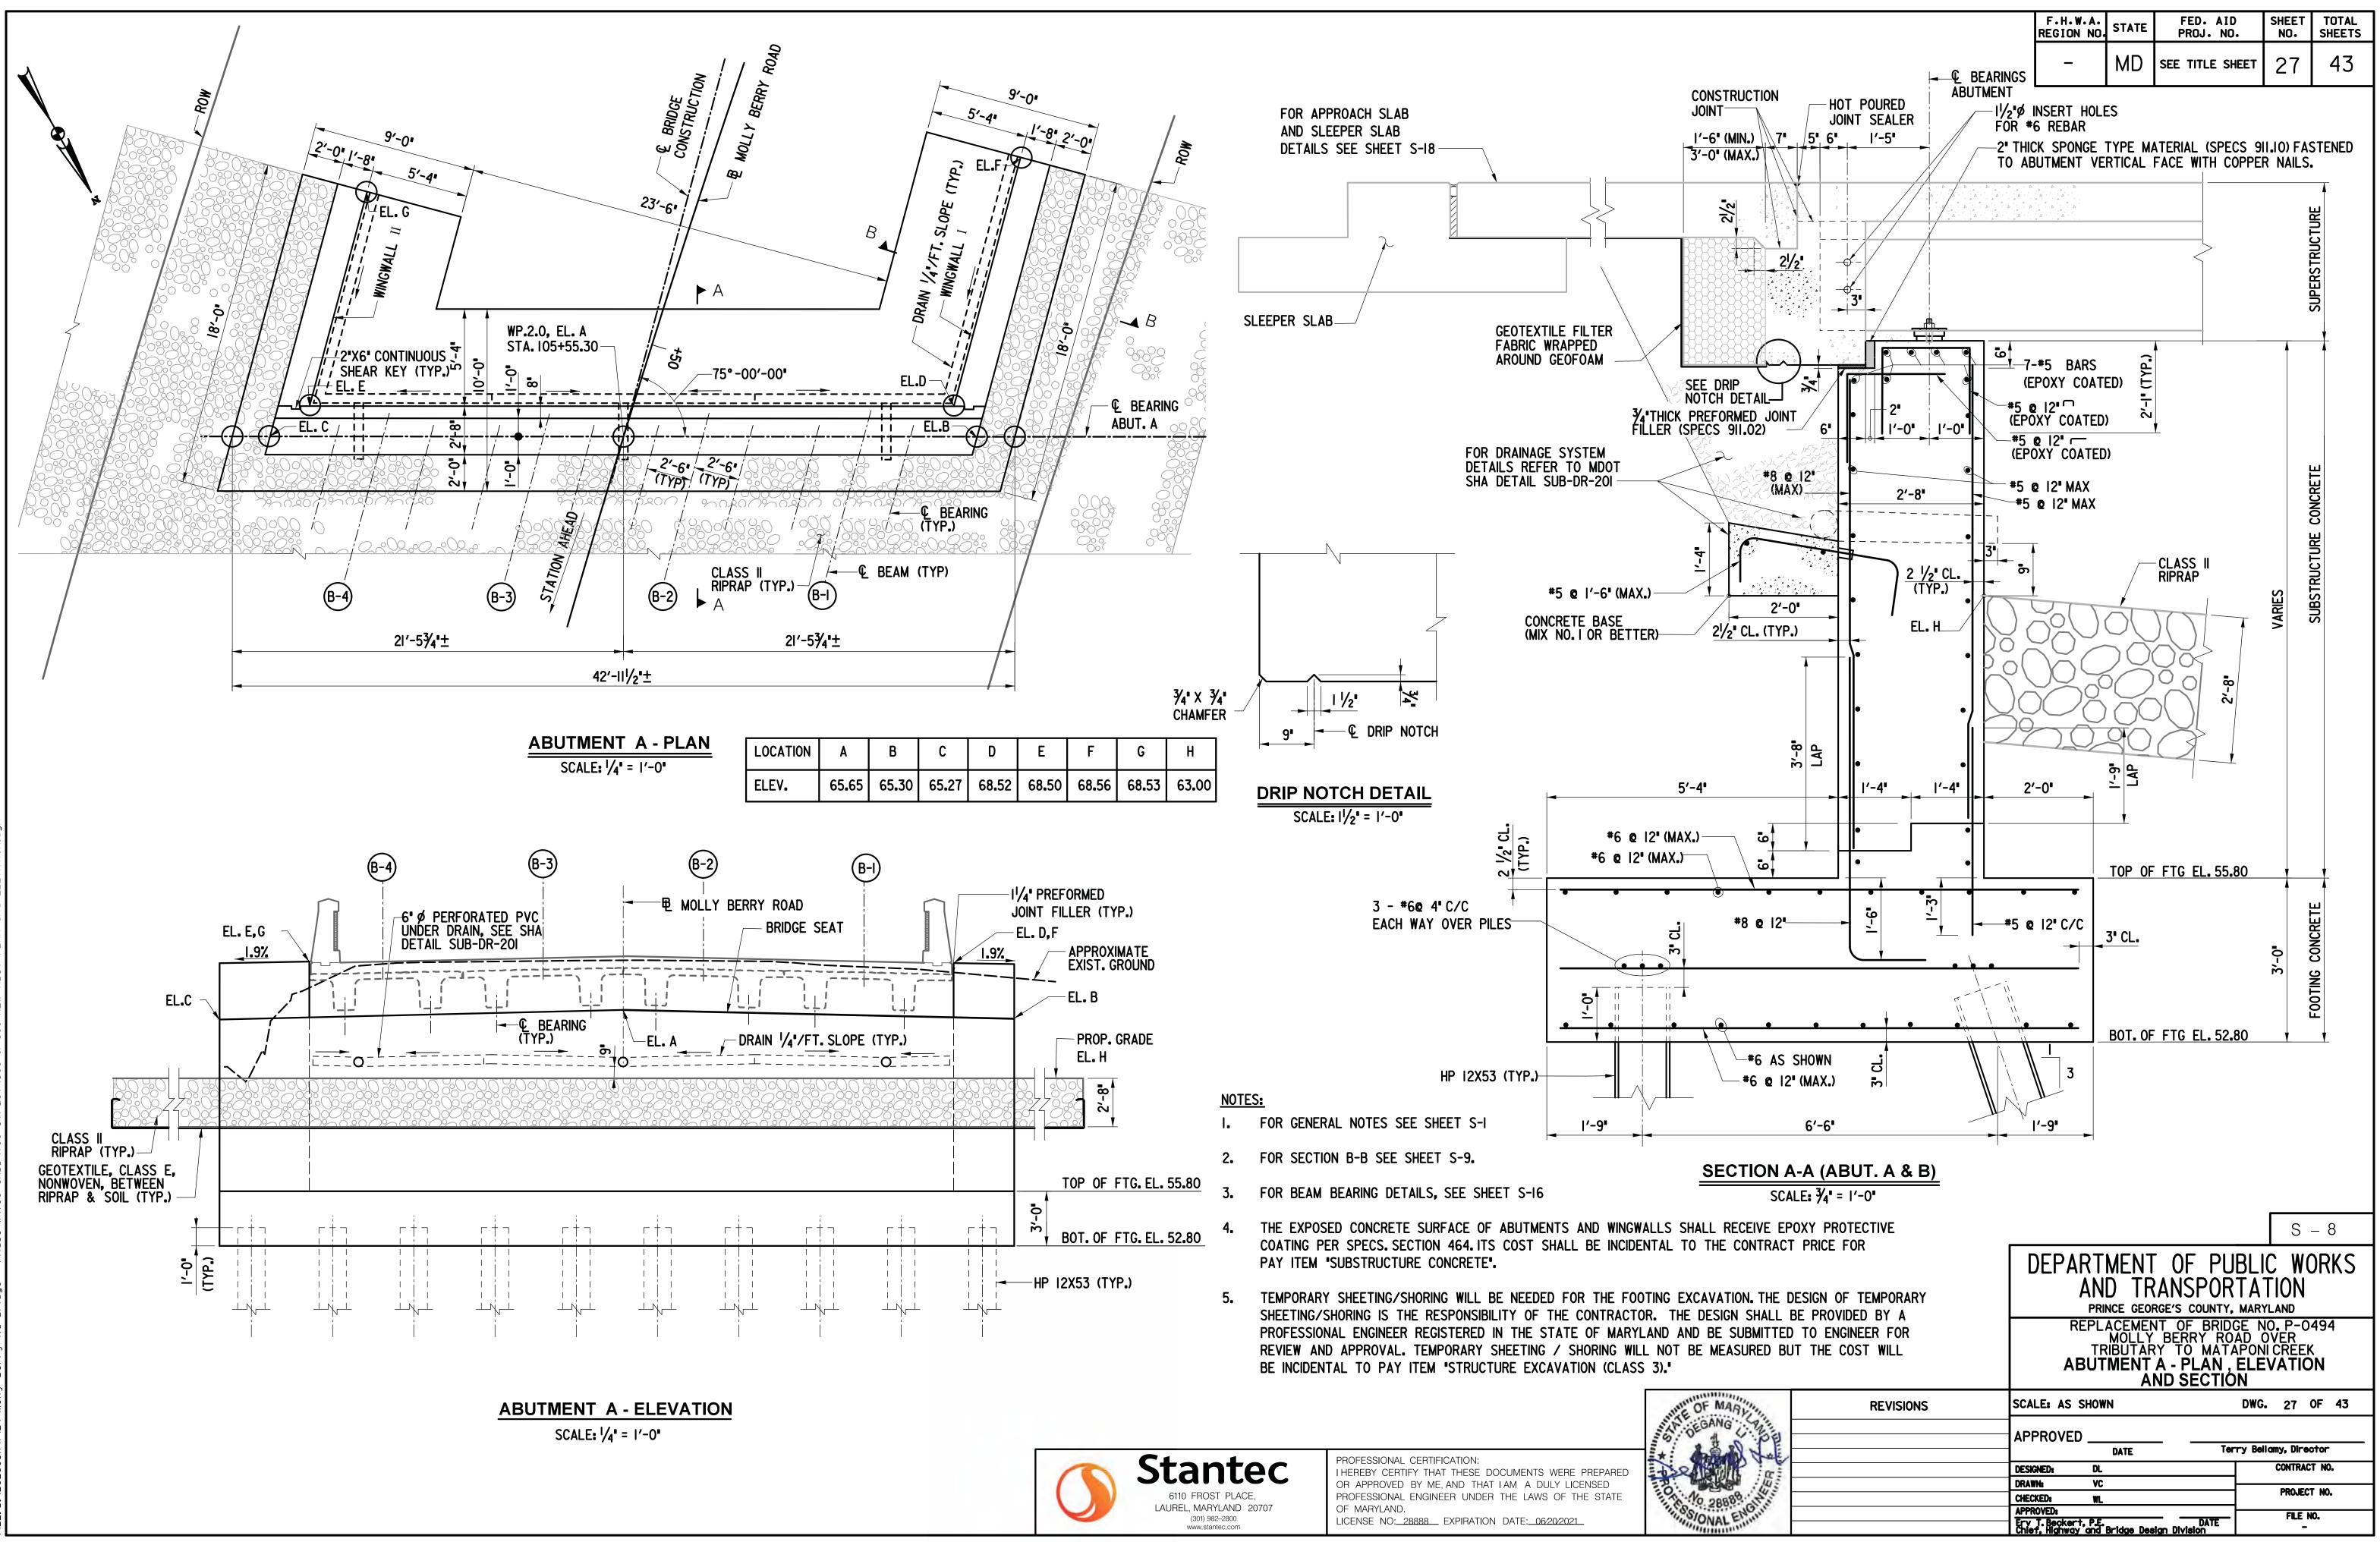
CHORAGE TO VERTICAL FACE D5.411) (37.5 LF)	TYPE C TRAFFIC BARRIER END TREATMENT (MD 605.03) (50 LF)	) GALVANIZED W BEAM TRAFFIC BARRIER USING 8-F1 (MDSHA STD. NO. 605.22)			
	I EA   STA. 104+39.15, 13.69' LT     I EA   STA. 107+08.20, 14.91' LT     I EA   STA. 108+12.50, 14.00' RT	100 LF STA. 106+62.50, 14.63' RT TO STA. 107+62.50, 14.00' RT			
	CONCRETE BARRIER AT BRIDGE END (SEE SHEET S-18 FOR DETAIL)				
	IO LF RESIDENTIAL DRIVEWAY, STA. 105+39.56, 18.8' RT				

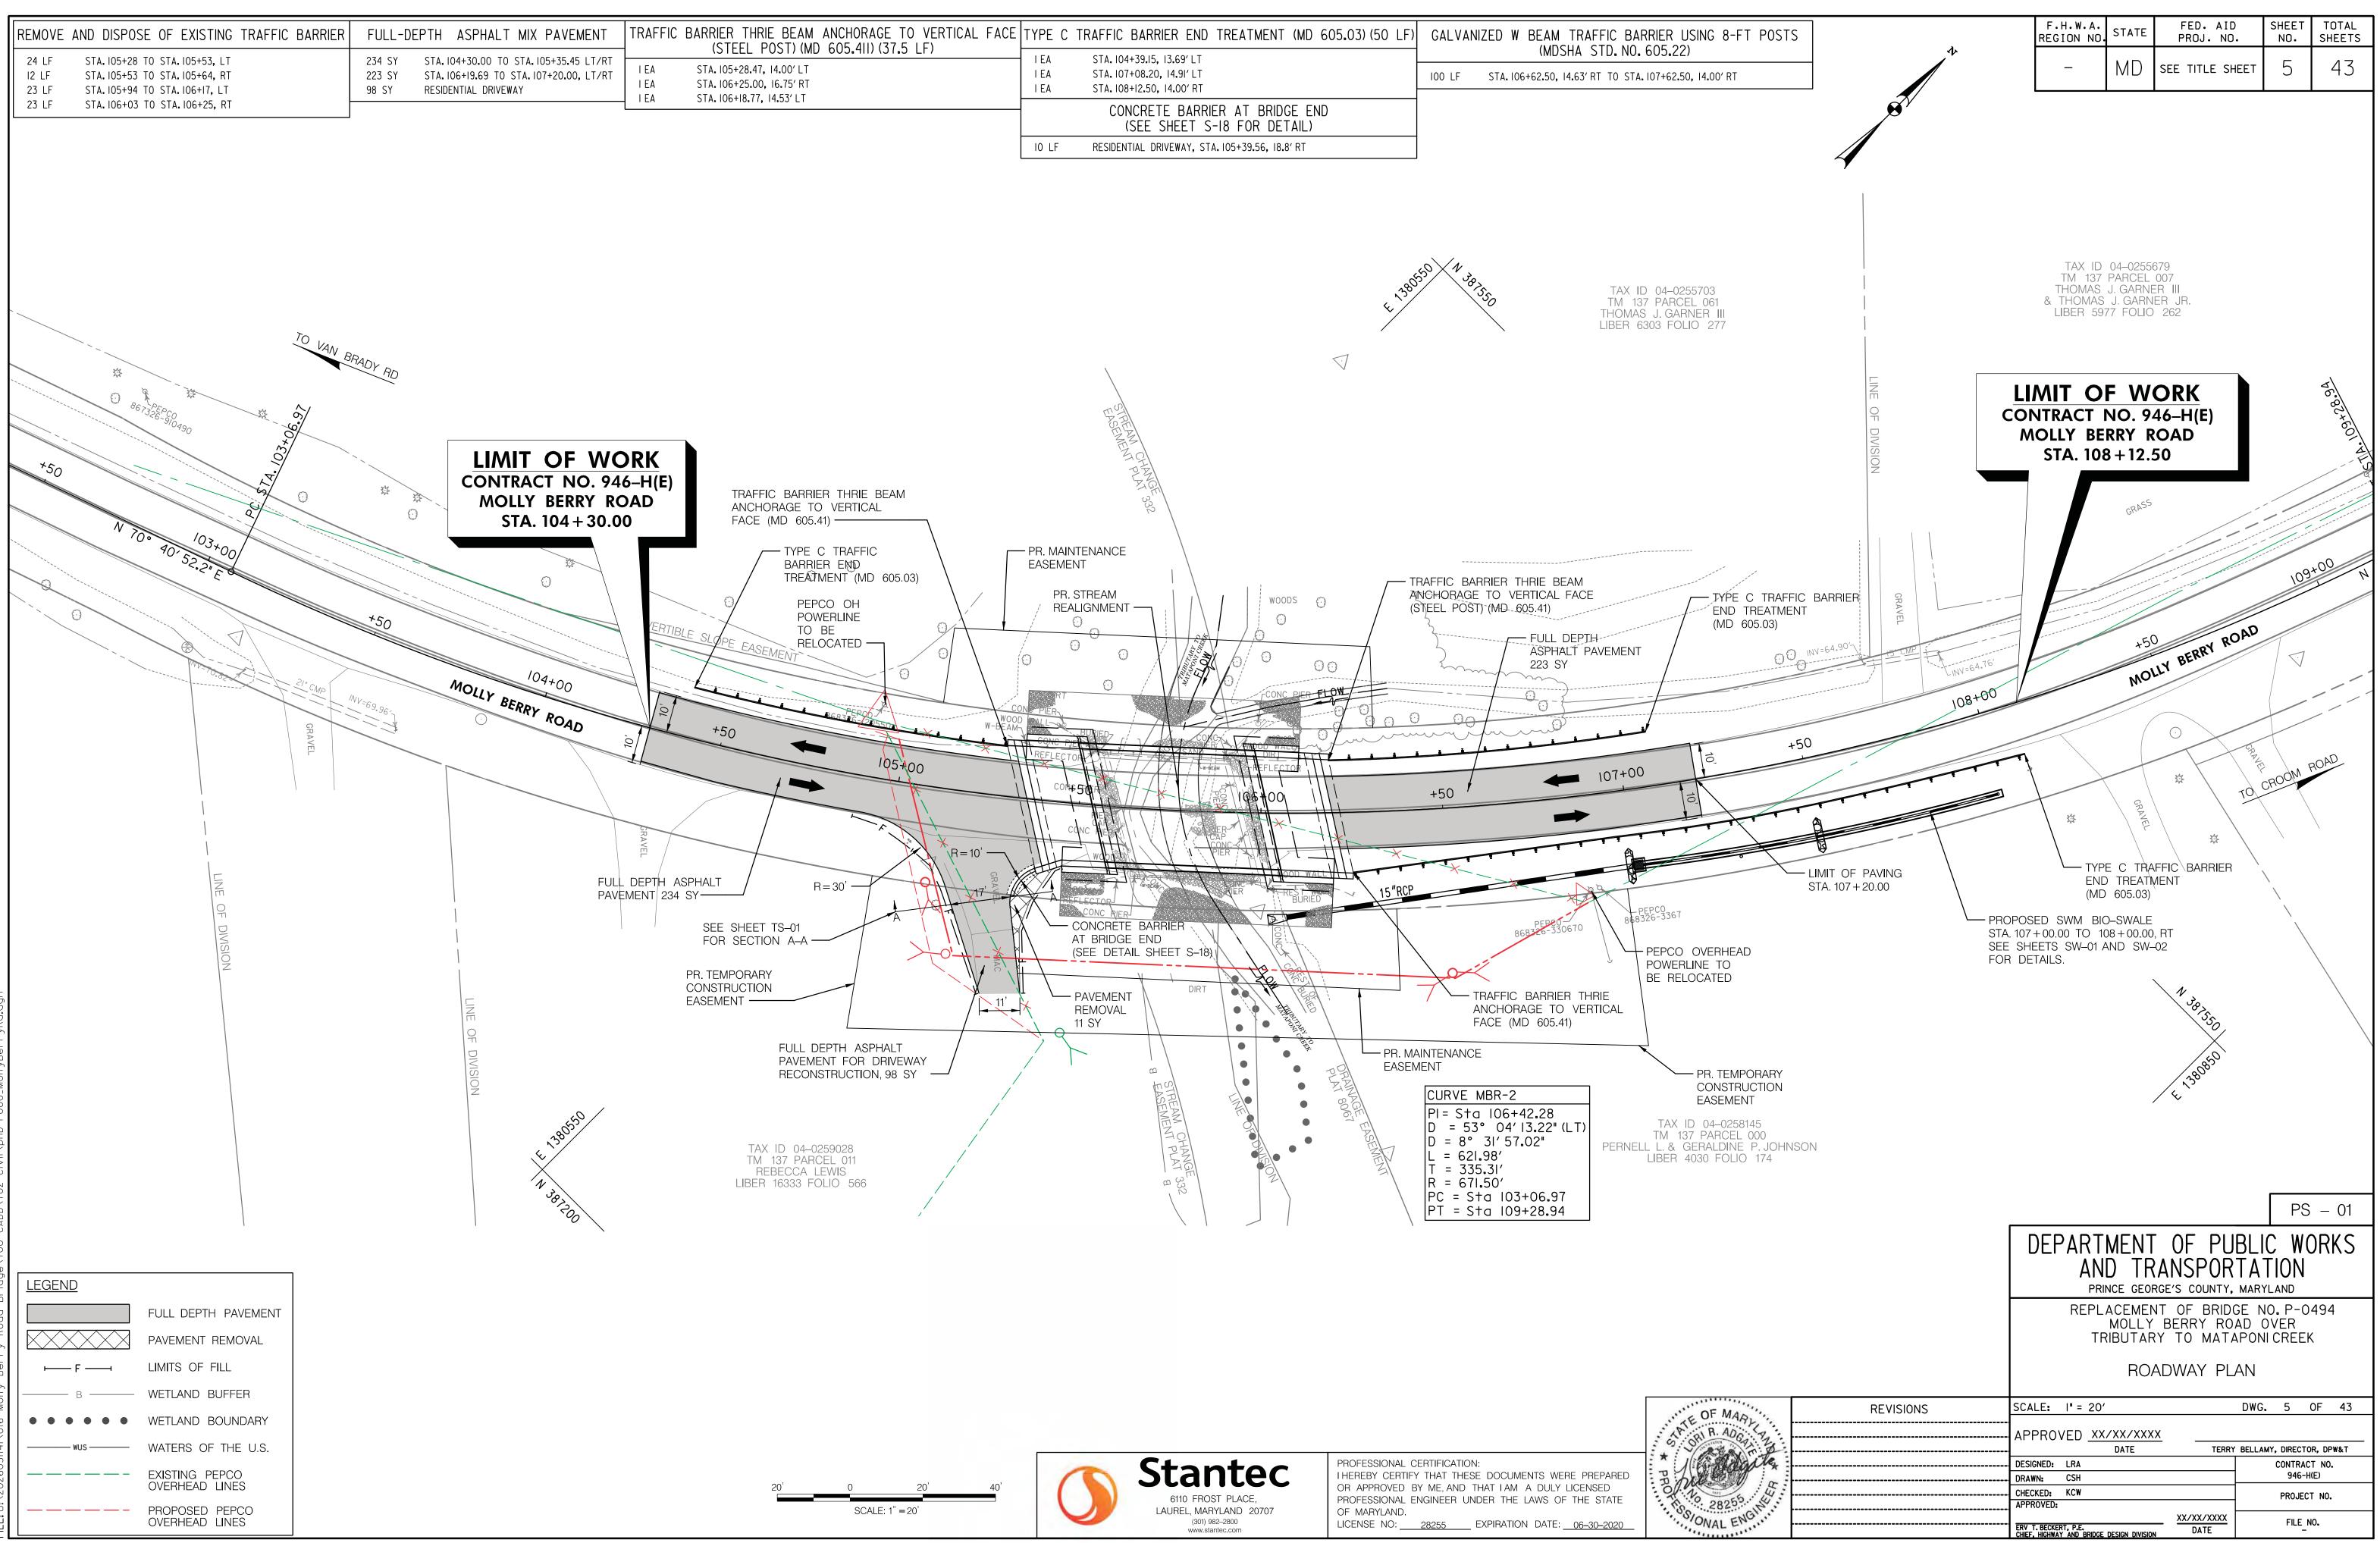


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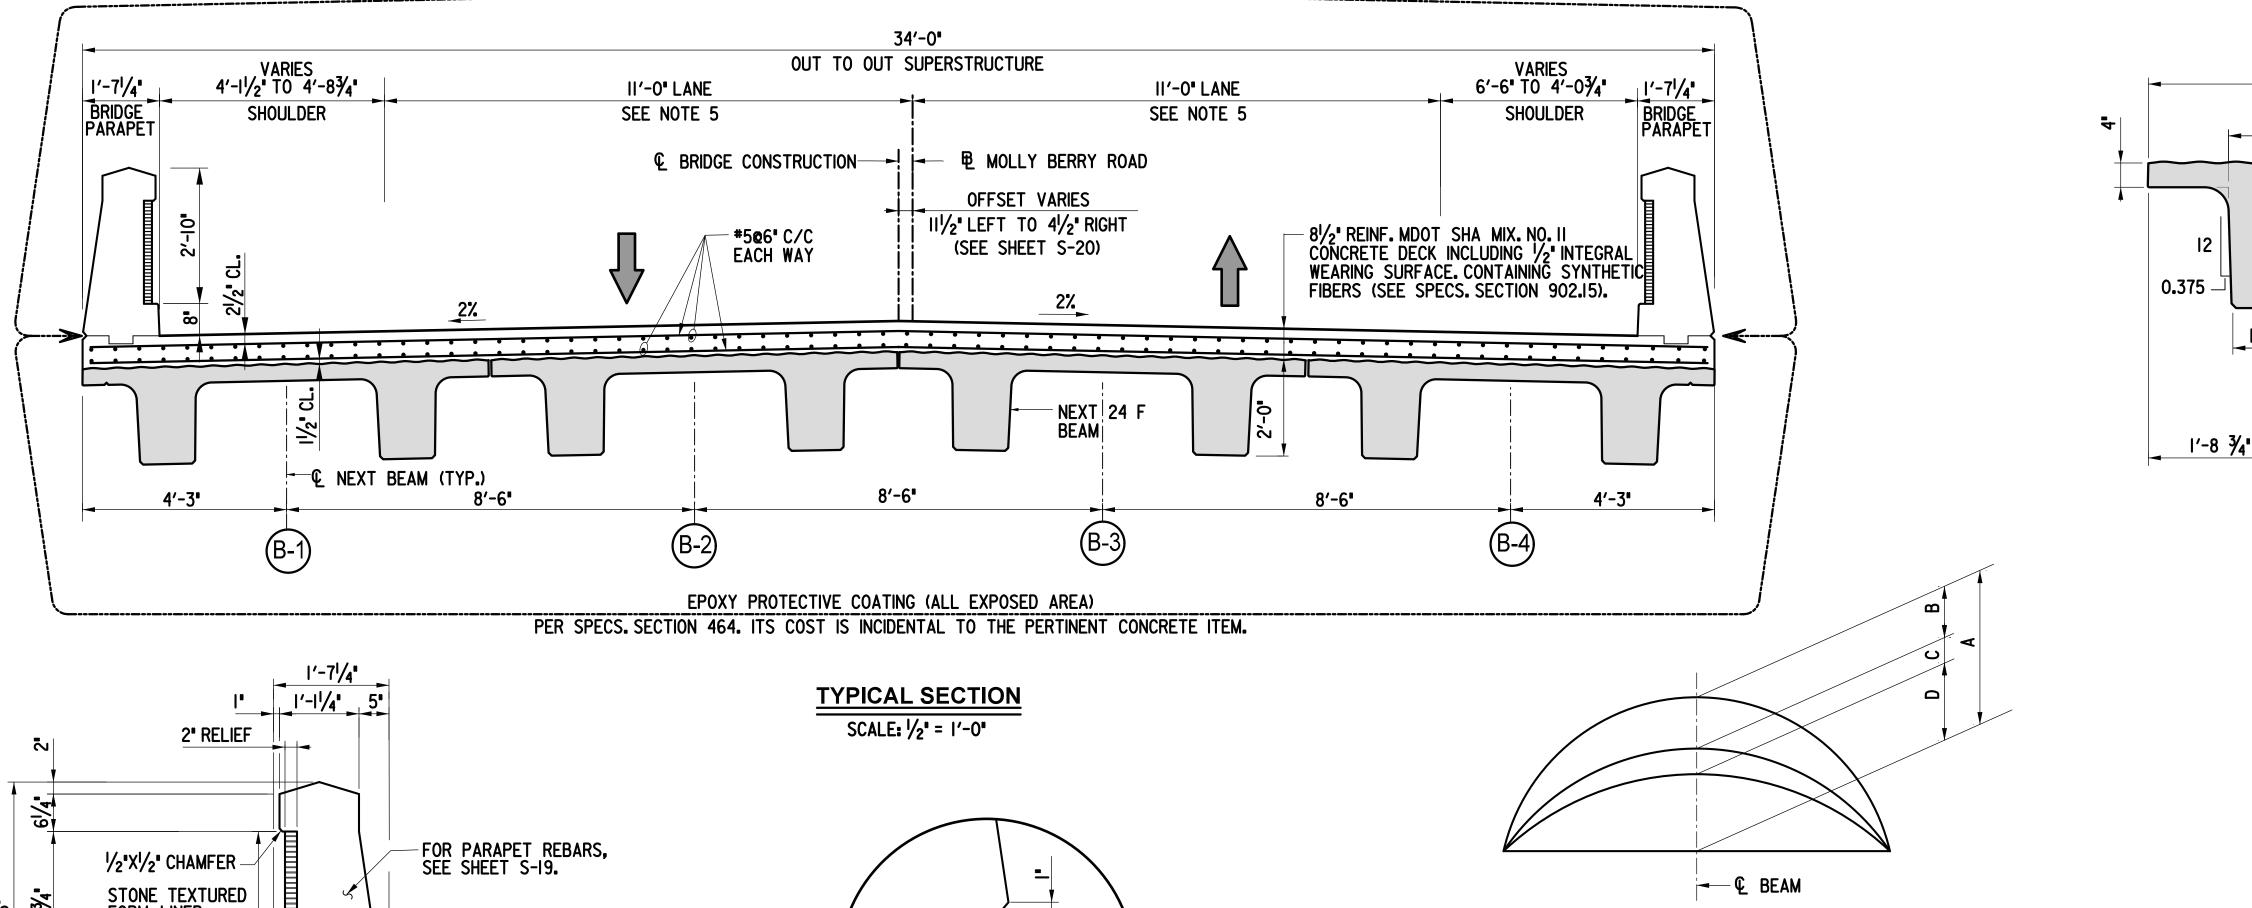
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	F.H.W.A. REGION NO.	STATE	PROJ. NO.	NO.	SHEETS
)	-	MD	SEE TITLE SHE	ЕТ 22	43
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	AN	D TR	ANSPOR	<b>TATION</b>	
	REPL		RGE'S COUNTY, I NT OF BRIDG BERRY ROA RY TO MATAI	E NO. P-O	494
			LAN AND E		
80.11	CALE: AS SHOW	N		DWG. 22	UF 43
AF	PPROVED	DATE	Terr	y Bellamy, Dire	
DE	SIGNED: DL XAWN: VC			CONTRAC	T NO.
DR					T 140
CH	ECKED: WL PROVED: 7 T. Beckert, P.E. Nef, Highway and			PROJEC	

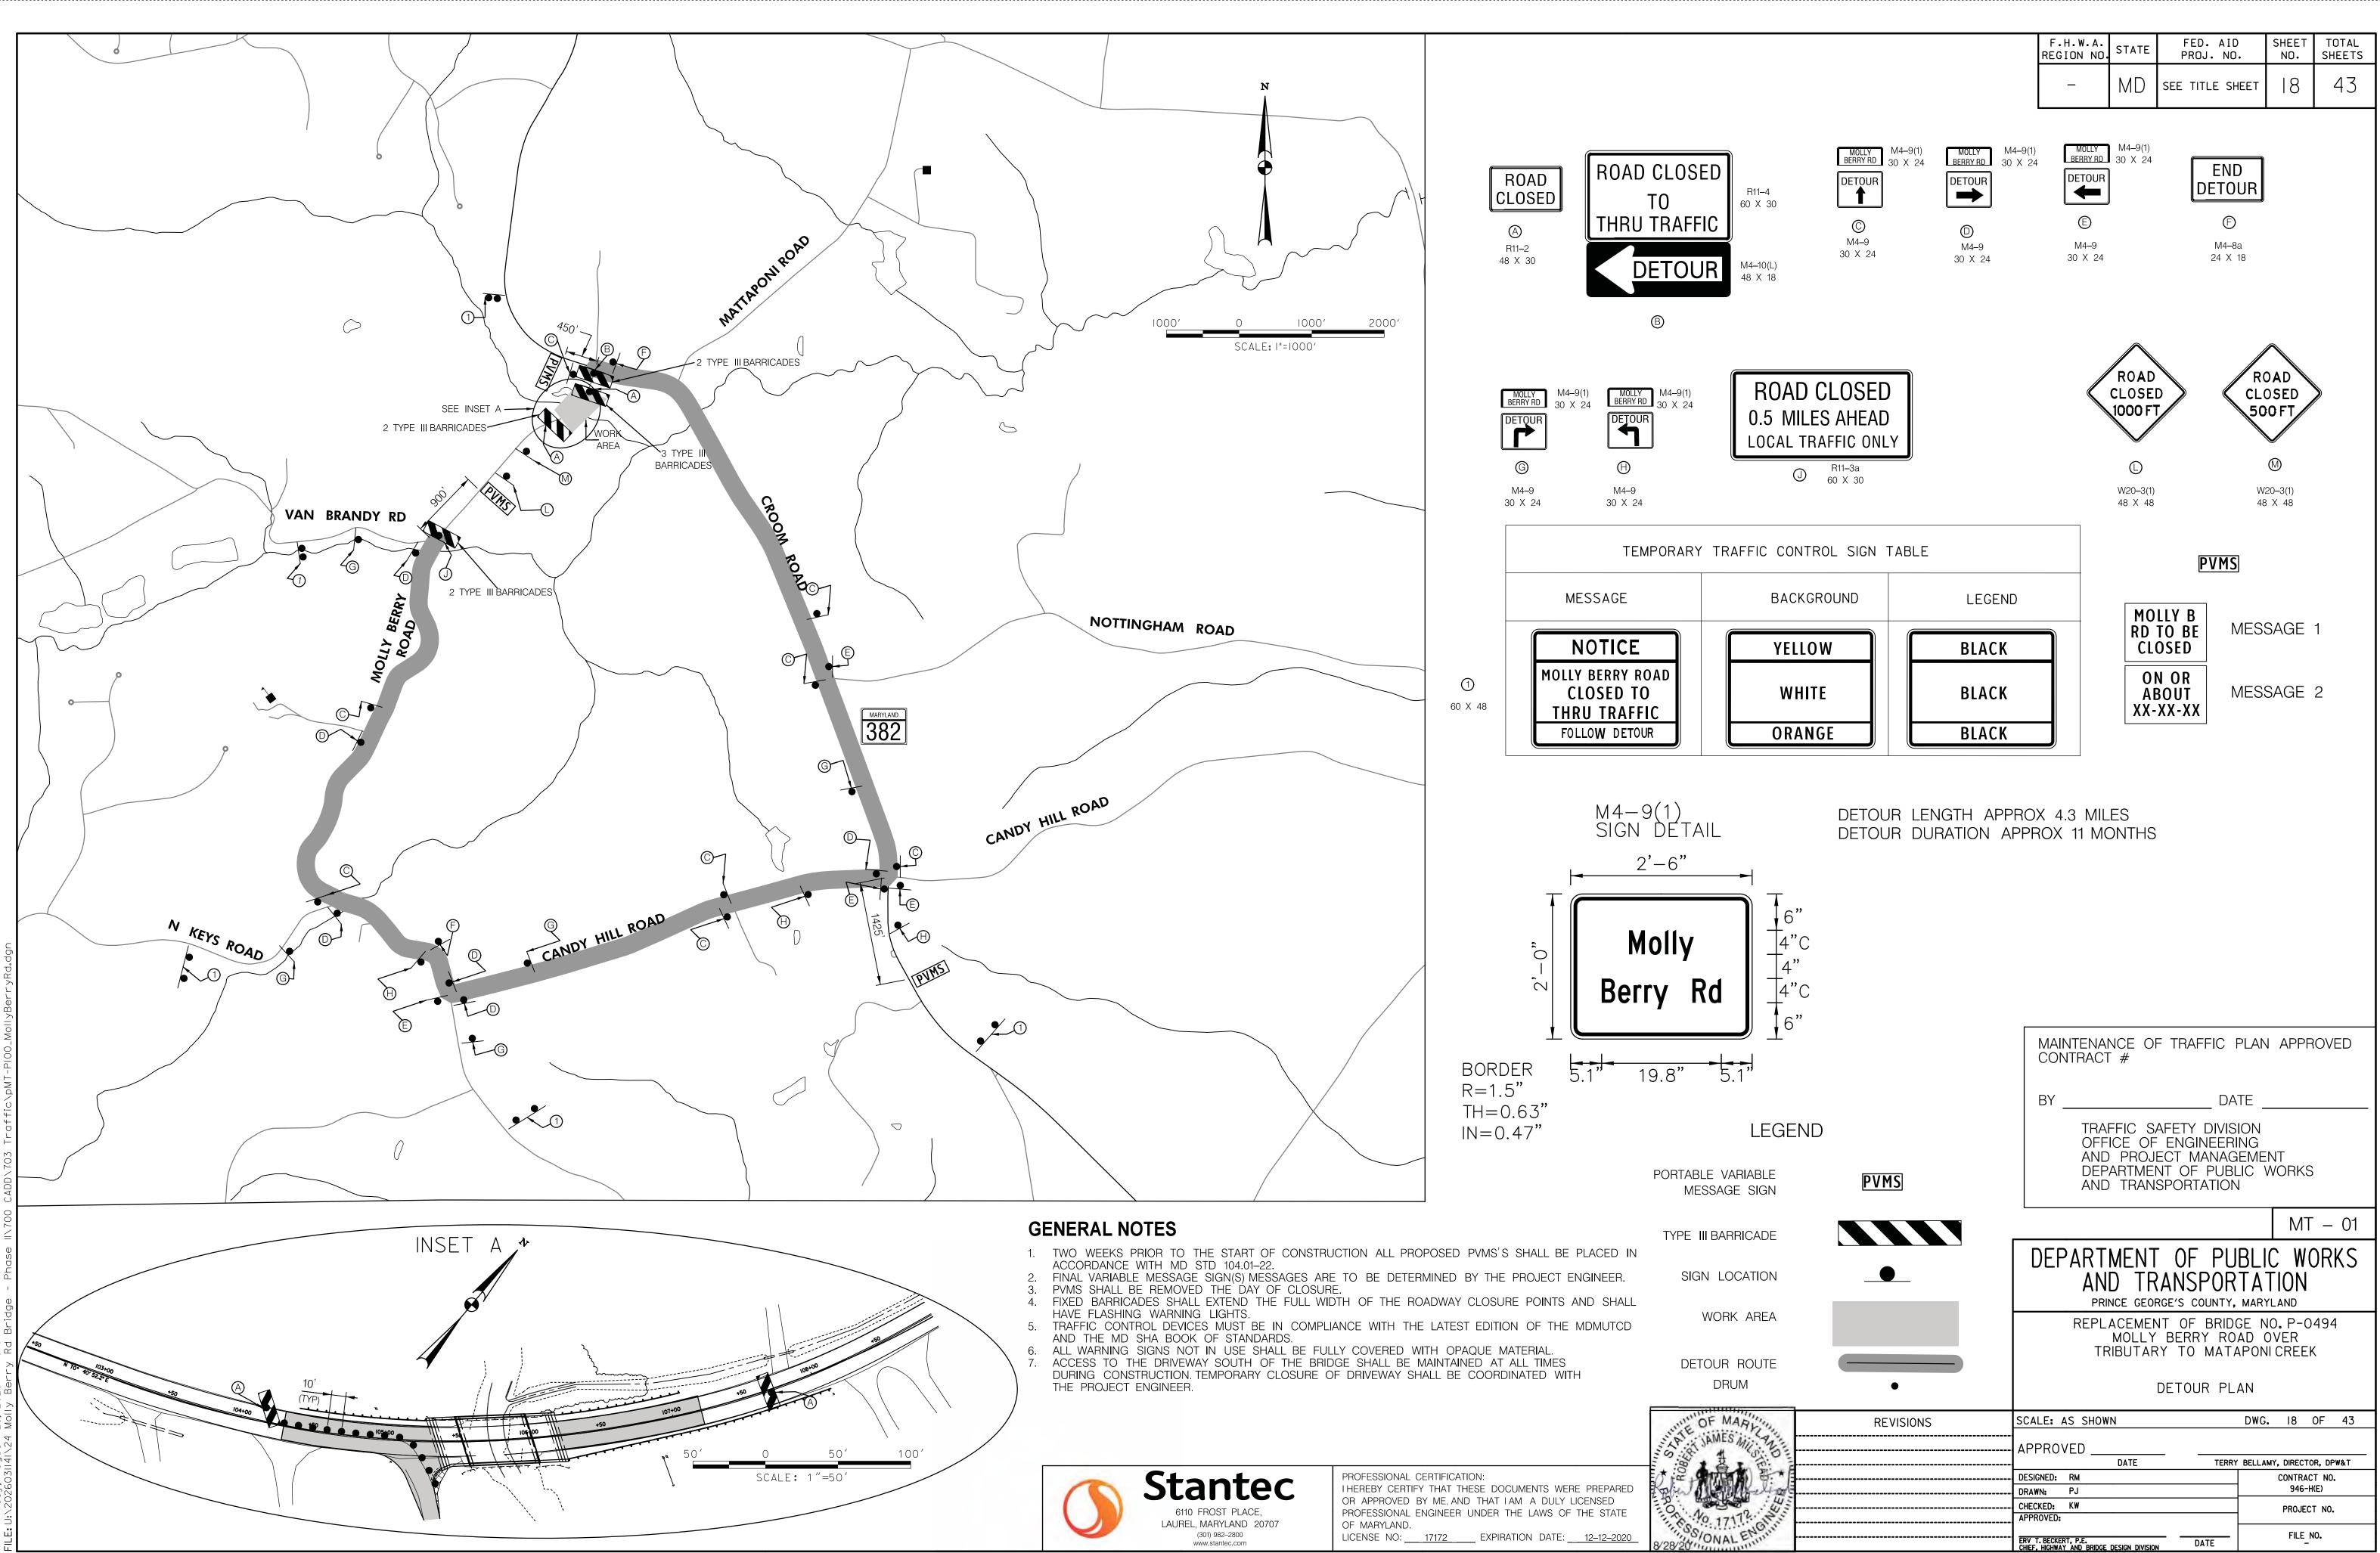






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CATION	Α	В	С	D	E	F	G	Н
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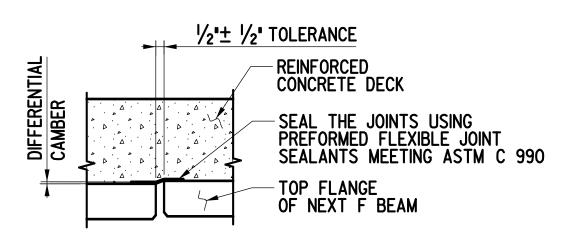


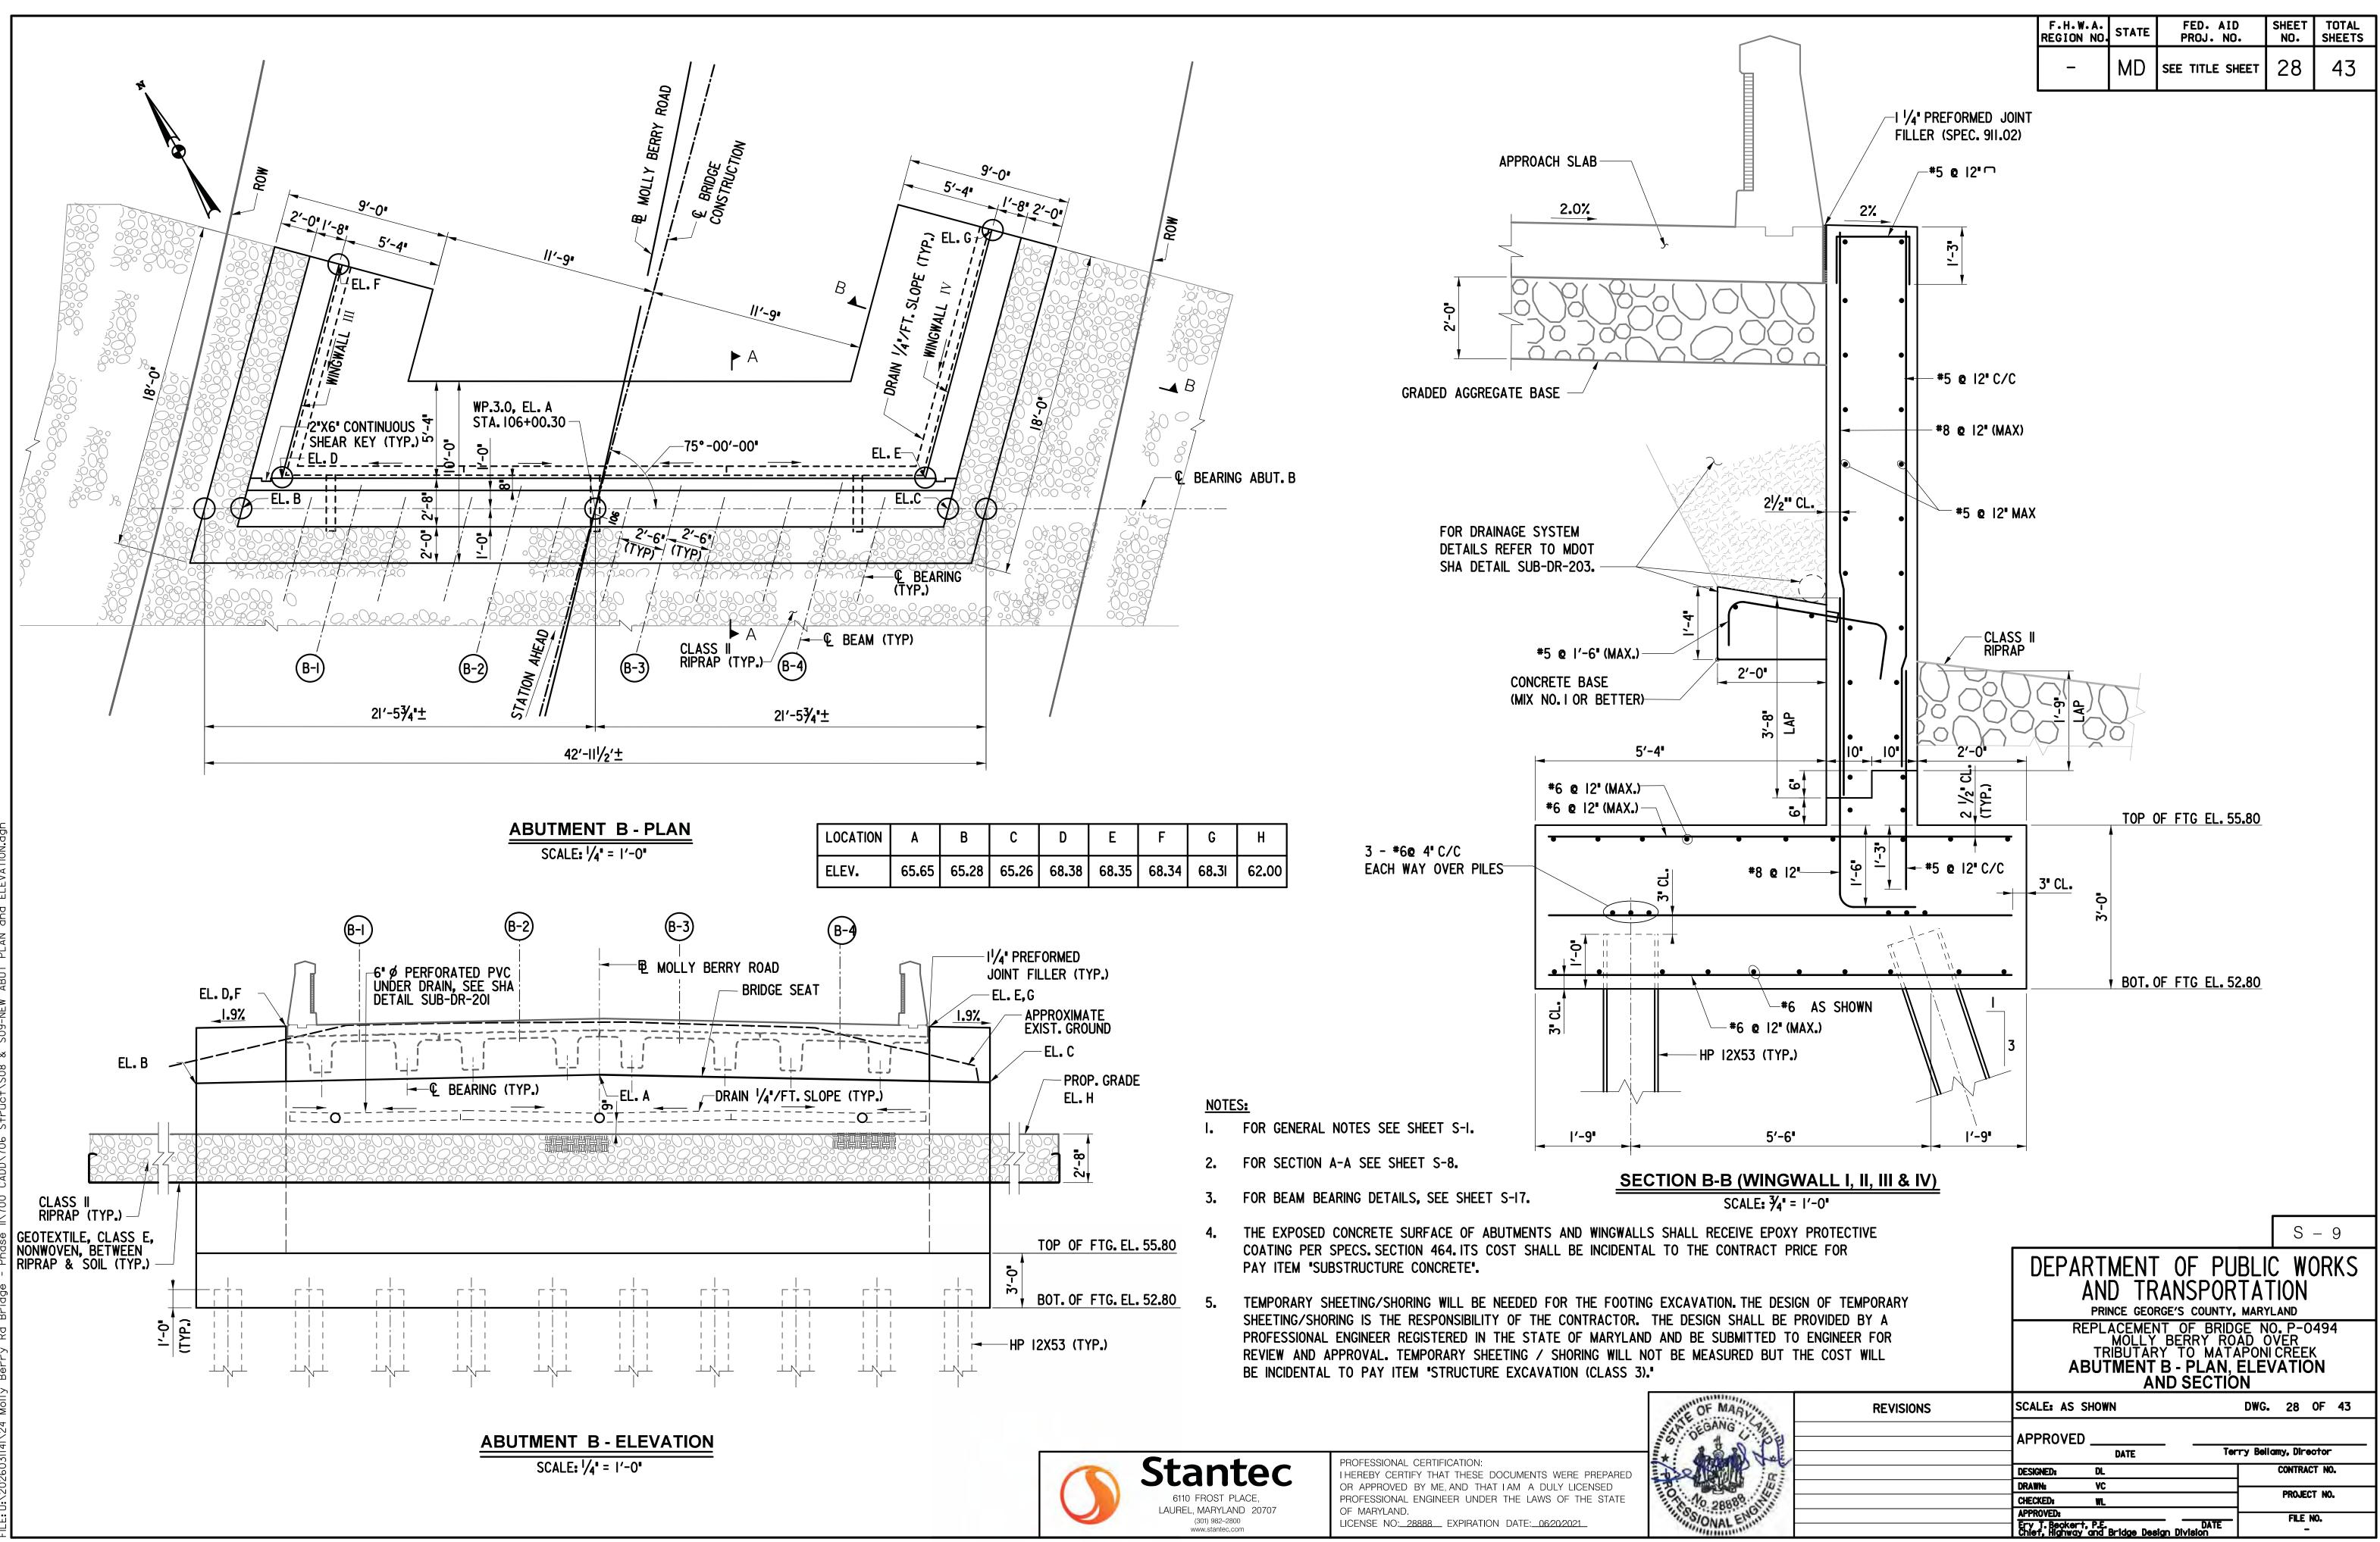

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**GROOVE DETAILS** SCALE: 11/2"= 1'-0" (DRIP EDGE IN EXTERIOR FLANGE OF EXTERIOR BEAM ONLY)
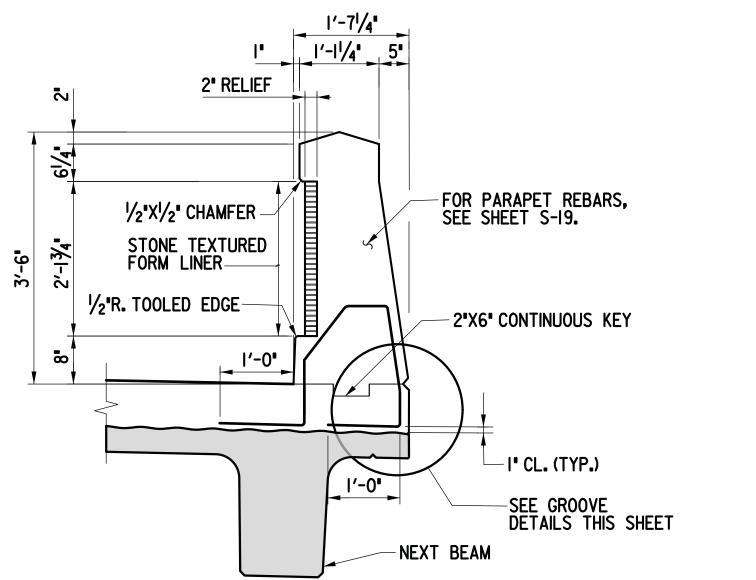
## **BRIDGE PARAPET** (PARAPET REBARS/ DECK REBARS NOT SHOWN) SCALE: 3/4"= 1'-0"

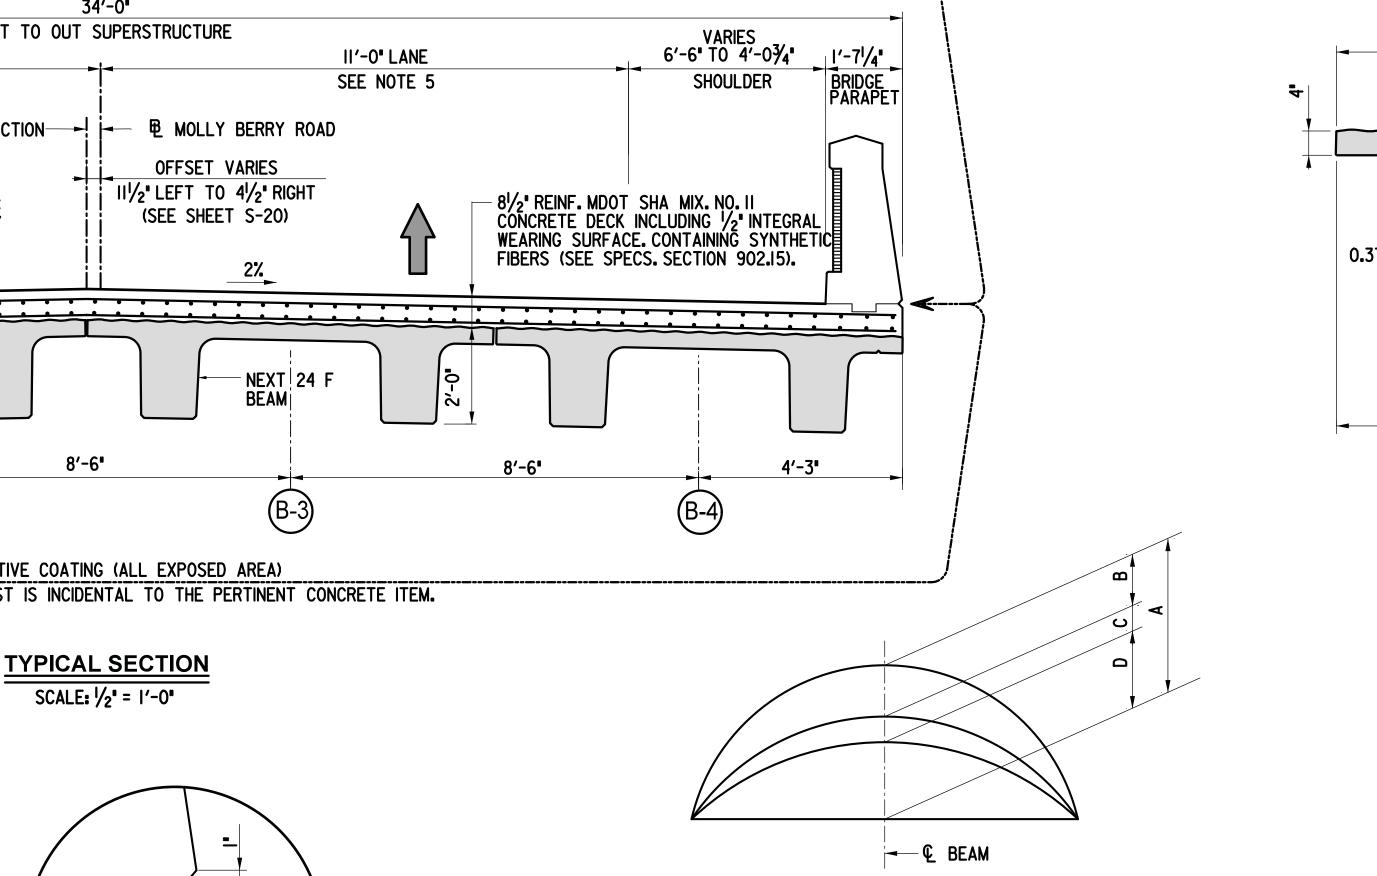

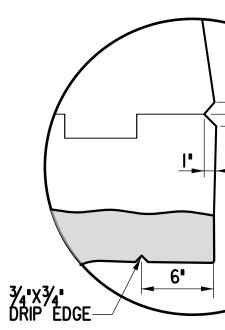

# NOTES:

- THE ACTUAL WIDTH OF THE BEAM TAKES INTO ACCOUNT A NOMINAL  $\frac{1}{2}$ " WIDE GAP BETWEEN BEAMS TO ACCOUNT FOR TOLERANCES. THE SPACING OF BEAMS ON A TYPICAL BRIDGE SHALL BE AT THE NOMINAL SPACING (EX.: BEAM SPACING = 8'-6" FOR THE 8'-5!/2" SECTION).
- 2. THE STEM WIDTH AND SPACING ARE FIXED.
- 3. THE FLANGE OVERHANG SHOULD BE CHAMFERED 6"X6" IN ORDER TO MINIMIZE CASTING AND HANDLING DAMAGE.
- 4. NO SPECIAL DECK POURING SEQUENCE IS REQUIRED. THE ENTIRE BRIDGE DECK CAN BE PLACED IN ONE CONTINUOUS POUR.
- 5. THE ROADWAY LANE WIDTH IS 10'-0". THE LANE WIDTH TRANSITIONS FROM 10'-0" TO 11'-0" ON BRIDGE APPROACH SLAB AND SLEEPER SLAB.

## CAMBER DIAGRAM SCALE: NTS

## CAMBER NOTES:

CAMBER DUE TO PRESTRESS PLUS SLAB DEAD LOAD TO BE CHECKED IN THE FIELD.

THE THICKNESS OF THE CONCRETE DECK SHALL BE VARIED TO COMPENSATE FOR ANY INACCURACIES IN THE CAMBER OF SLABS.

PRESTRESS CAMBER AND DEAD LOAD DEFLECTION DATA SHOWN IS THEORETICAL AND MAY VARY WITH CONCRETE STRENGTH. VARIABLE PRESTRESSING CONDITIONS AND PRESTRESS LOSSES.

CAMBER IN SLAB WILL INCREASE DUE TO CONCRETE CREEP DURING STORAGE. PRECAUTIONS SHALL BE TAKEN BY LOADING OR OTHER MEANS TO PREVENT ADDITIONAL CAMBER FROM DEVELOPING DURING STORAGE OF PRESTESSED SLABS.

- A =  $1\frac{3}{8}$  ESTIMATE CAMBER DUE TO PRESTRESS (INCH)
- $B = \frac{1}{2}$  DEFLECTION DUE TO DEAD LOAD OF PRESTRESSED BEAM (INCH)
- $C = \frac{3}{8}$  DEFLECTION DUE TO DEAD LOAD OF CAST-IN-PLACE
- CONCRETE DECK, AND CONCRETE PARAPET (INCH)
- $D = \frac{1}{2}$  NET FINAL CAMBER (INCH)


THE END OF THE BEAMS SHOULD BE SKEWED FOR SKEWED BRIDGES. THE ACUTE CORNERS OF





6110 FROST PLACE,

(301) 982–2800

www.stantec.com

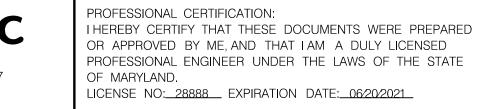

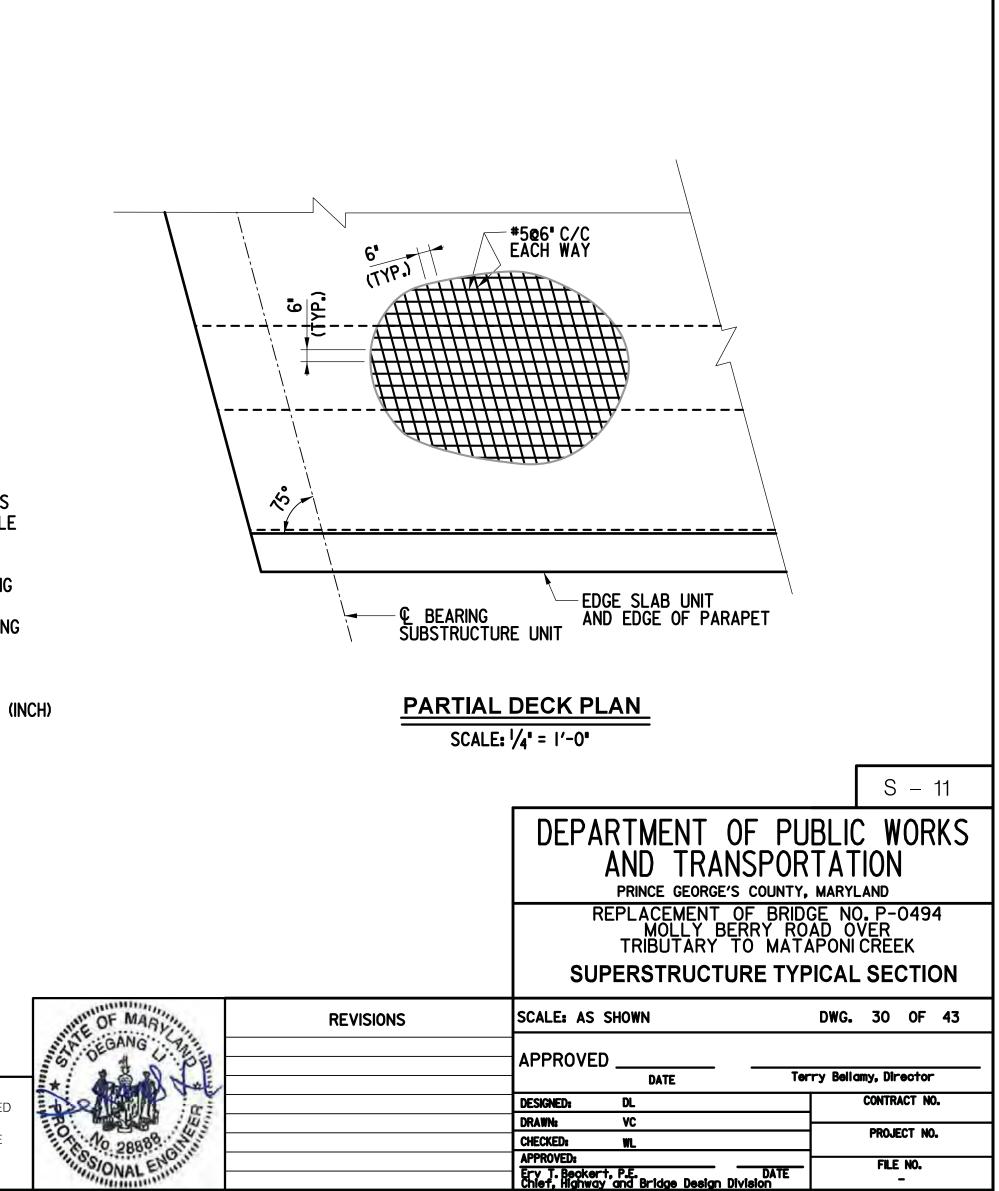

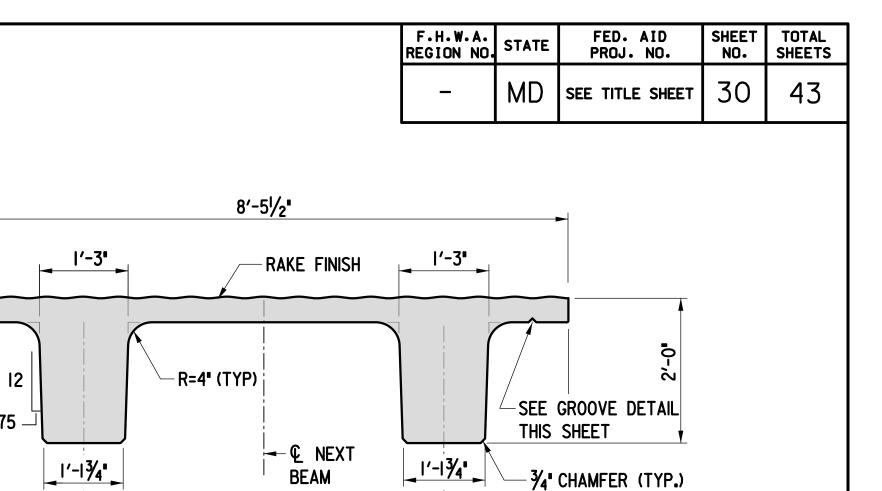


5'-0"

**SECTION DIMENSIONS** 

SCALE: |" = |'-0"

|'-8¾**"** 

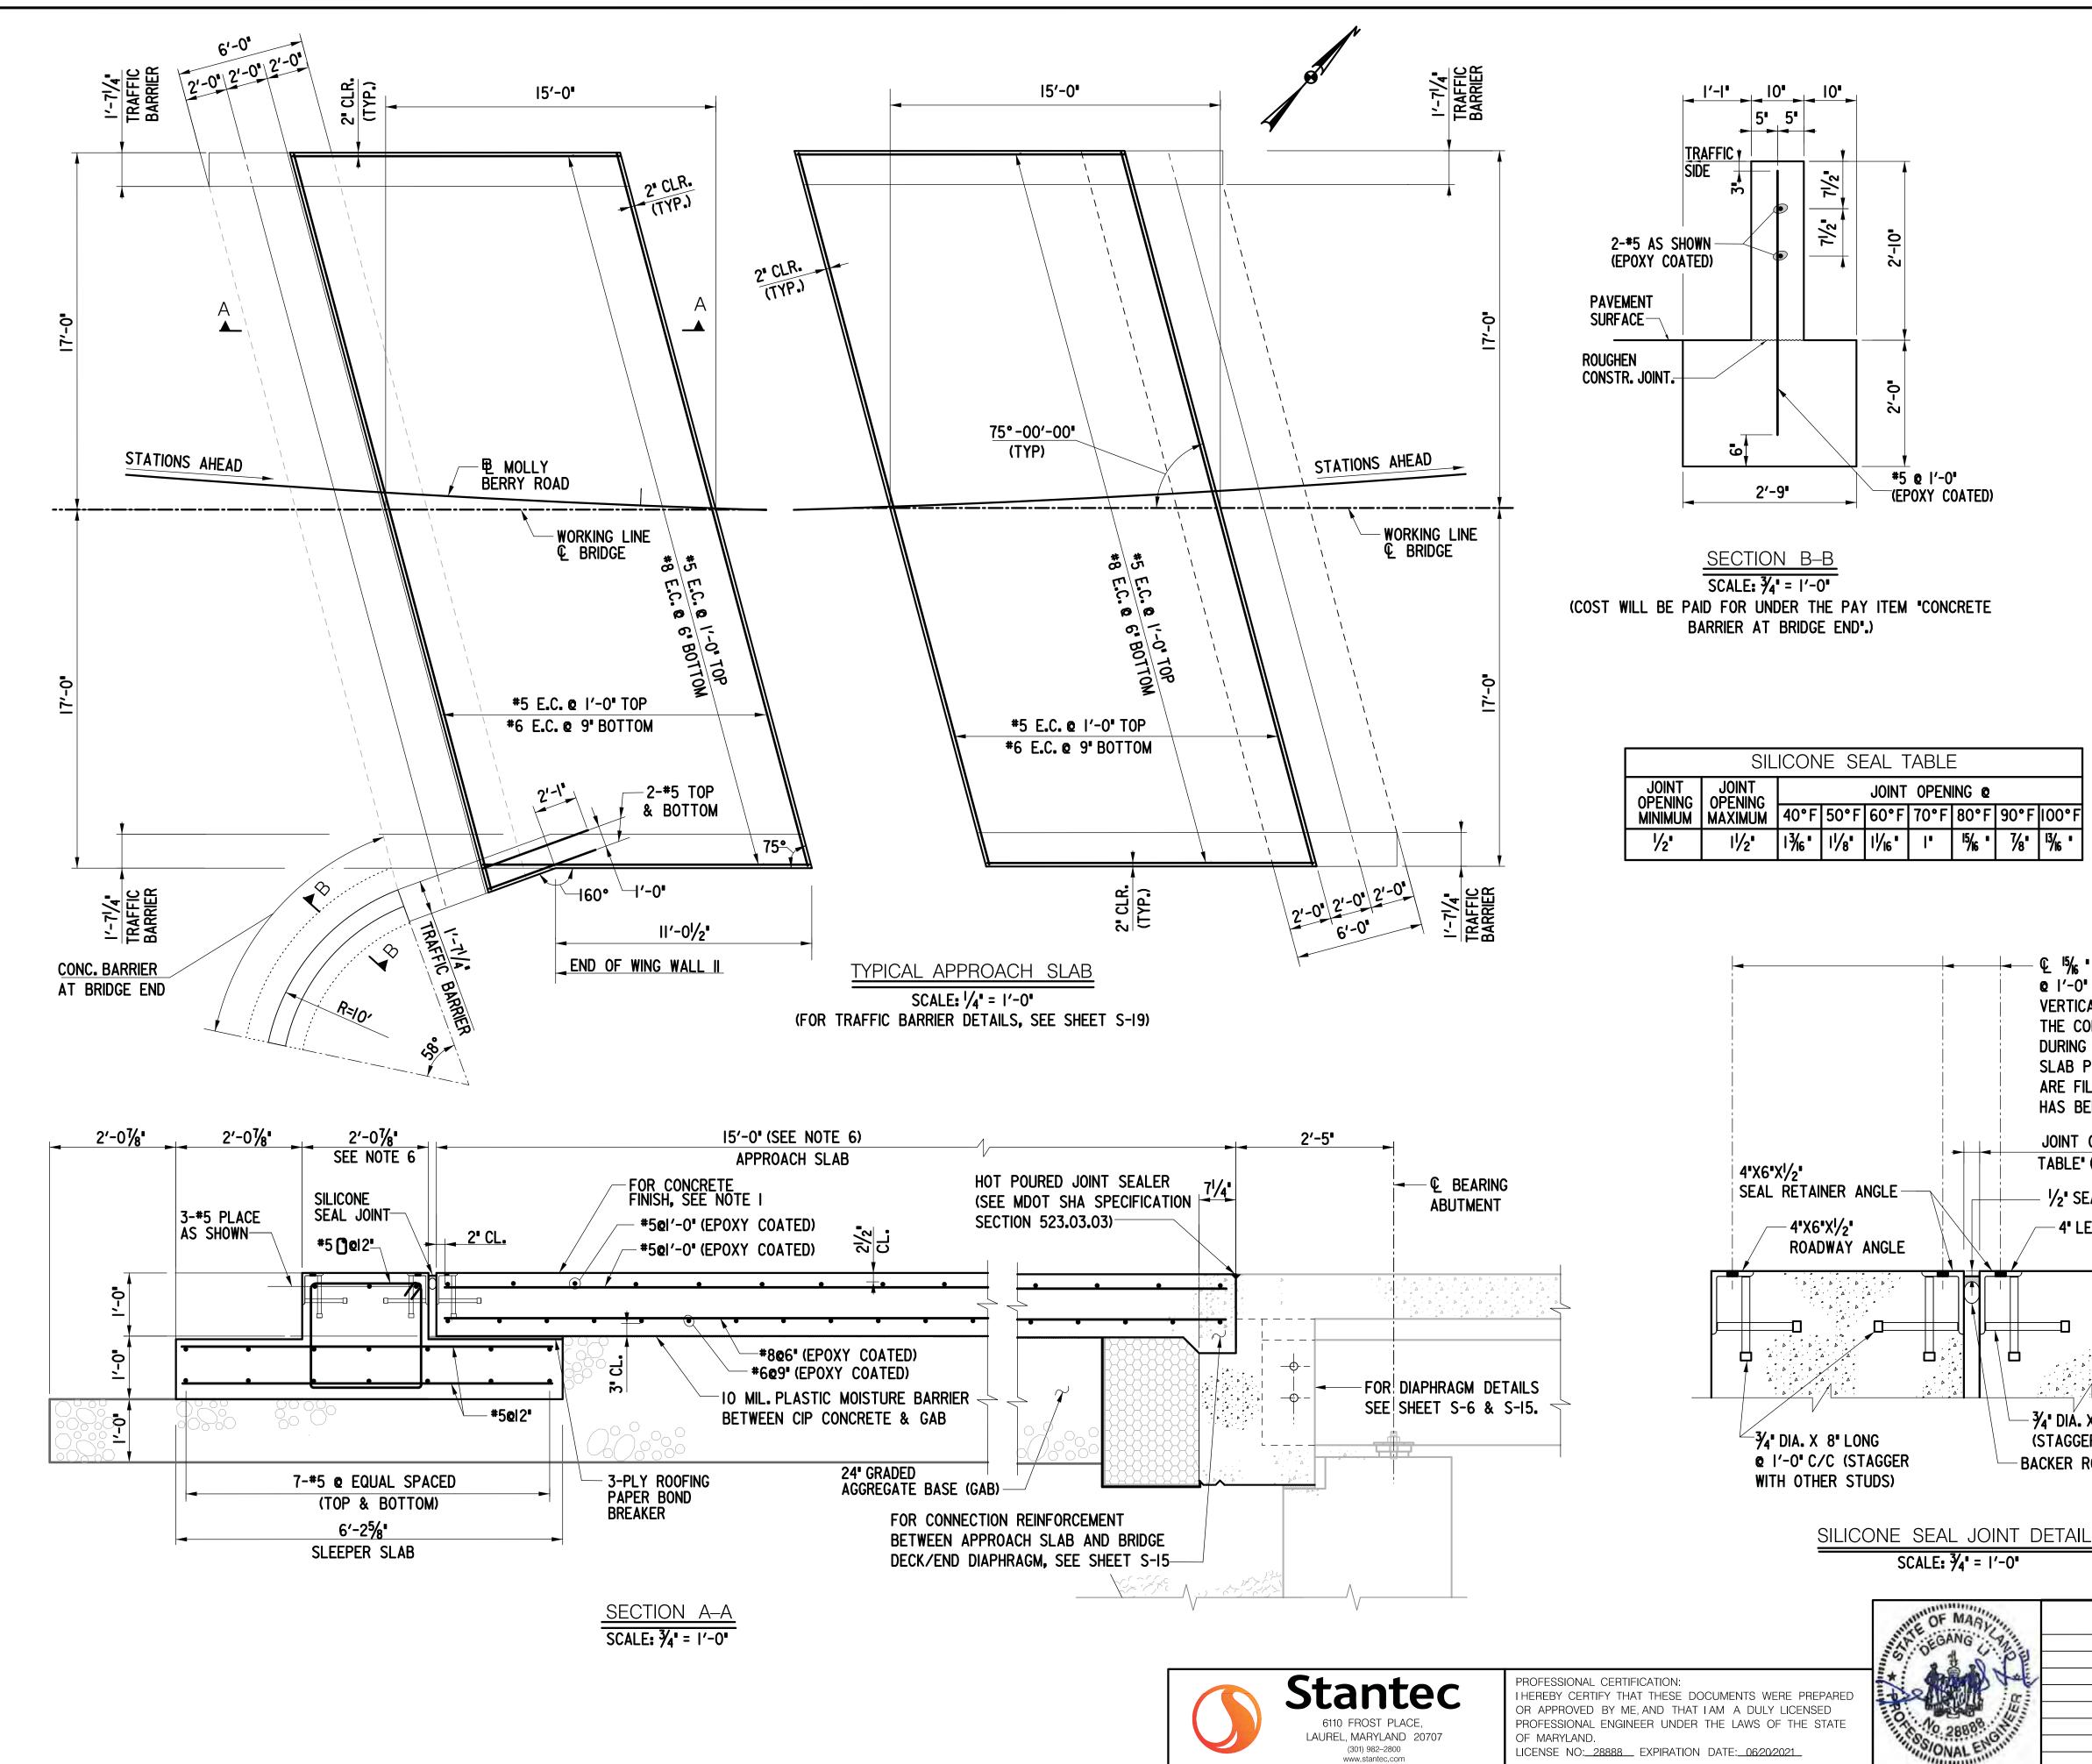

SILICONE SEAL TABLE							
JOINT OPENING	JOINT OPENING	JOINT OPENING Q					
MINIMUM	MAXIMUM	40°F	50°F	60°F	70°F	80°F	ſ
1/2 <b>'</b>	ı½ <b>'</b>	<sup>3</sup> / <sub>6</sub> "	۱ <mark>//</mark> 8"	<b>الا</b> ال	"	<sup>15</sup> ⁄16 "	

F.H.W.A. REGION NO.	STATE	FED. AID PROJ. NO.	SHEET NO.	TOTAL SHEETS
-	MD	SEE TITLE SHEET	37	43

### NOTES FOR APPROACH SLAB:

- I. FOR CONCRETE FINISH, SEE MDOT SHA SPECIFICATION SECTION 420.03.07, FINISHING CONCRETE SURFACES. PAY PARTICULAR ATTENTION TO ITEM 420.03.07(d.I), SLAB GROOVING.
- 2. ANY DAMAGE TO THE EPOXY COATING ON THE BARS AS A RESULT OF CONSTRUCTION SHALL BE REPAIRED USING A FIELD TOUCH UP KIT.
- 3. CONCRETE FOR APPROACH SLAB SHALL BE MIX NO. II.
- 4. THE APPROACH SLAB BASE SHALL BE GRADED AGGREGATE IN CONFORMANCE WITH SHA SPECIFICATIONS SECTION 501.
- 5. THE GRADED AGGREGATE BASE OF APPROACH SLAB WILL NOT BE MEASURED FOR PAYMENT. ITS COST SHALL BE CONSIDERED AS INCIDENTAL TO THE APPROACH SLAB.
- 6. THE ROADWAY CONCRETE EXPOSED SURFACE SHALL RECEIVE SILANE PROTECTIVE COATING.

#### NOTES FOR ROADWAY ANGLES:

ROADWAY JOINT ANGLES SHALL RECEIVE COATING SYSTEM B PER SPECS 912.05. THE COLOR OF THE FINISH COAT SHALL CONFORM TO AMS-STD-595A, COLOR NO. 26440

<b>6</b>   V   T   C   S	2 15% " DIA. VENT HOLE 2 1'-0" C/C (AS CLOSE TO VERTICAL LEG AS POSSIBLE) THE CONTRACTOR SHALL VERIFY OURING APPROACH SLAB AND SLEEF SLAB PLACEMENT, THAT ALL VENT ARE FILLED WITH CONCRETE THAT HAS BEEN FORCED FROM UNDER AN	HOLES		
	JOINT OPENING SEE "SILICONE SEAL ABLE" (MEASURED NORMAL TO JOIN	T)		
 	1/2" SEALANT RECESS. SEALANT TH	ICKNESS 1/2"		
	- 4" LEG (TYP.) - TOP OF APPROACH SI			
3/	DIA. X 8' LONG STUD @ 1'-0' C/C			S – 18
• •	TAGGER WITH OTHER STUDS)			
BAC	KER ROD	DEPARTMENT OF AND TRANSF	PORTAT	<b>FION</b>
		PRINCE GEORGE'S CO	-	
	ETAILS	REPLACEMENT OF MOLLY BERRY TRIBUTARY TO	ROAD O	VER
-0"				-
		APPROACH SI		AILS
	REVISIONS	SCALE: AS SHOWN	DWG.	37 OF 43
P2		APPROVED		
L		DATE	Terry Bell	amy, Director
a		DESIGNED: DL		CONTRACT NO.
in the		DRAWN: VC CHECKED: WL		PROJECT NO.
and a state		APPROVED:		FILE NO.
		Ery T. Beckert, P.E. Chief, Hidbway, and Bridge Design Division	ATE	

